



REGIONE ABRUZZO - PROVINCIA DI TERAMO
COMUNE DI PIETRACAMELA

DESCRIZIONE:

**AMPLIAMENTO CIMITERO DI INTERMESOLI ALL'INTERNO DEL
PERIMETRO ESISTENTE**

CODICE C.I.G.: 71407816EA
CODICE C.U.P.: D61B15000470004

PROGETTO DEFINITIVO-ESECUTIVO

COMMITTENTE:

AMMINISTRAZIONE COMUNALE DI PIETRACAMELA

IL SINDACO:

Dott. Michele Petraccia

IL RESPONSABILE DEL PROCEDIMENTO:

Arch. Domenico Turla

PROGETTISTA:

Ing. Claudia Moriconi

Via Risorgimento 8, 64044 Fano Adriano (TE)
tel.: 347.9504092
pec: claudia.moriconi@ingte.it

ELABORATO:

PROGETTO ARCHITETTONICO


NUM. TAV.:

07


SCALA: /

DATA: LUGLIO 2017

SCHEMA FUNZIONALE_ SCALA 1:500

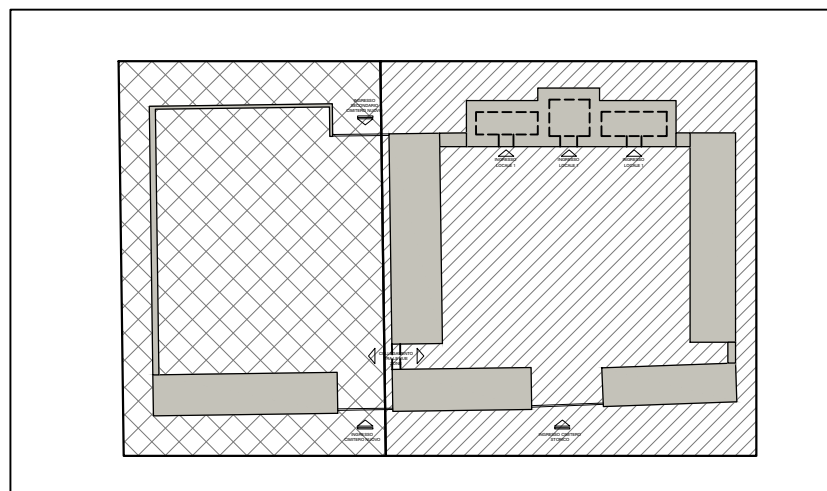


PLANIMETRI CON INDICAZIONE DEGLI INTERVENTI_ SCALA 1:200

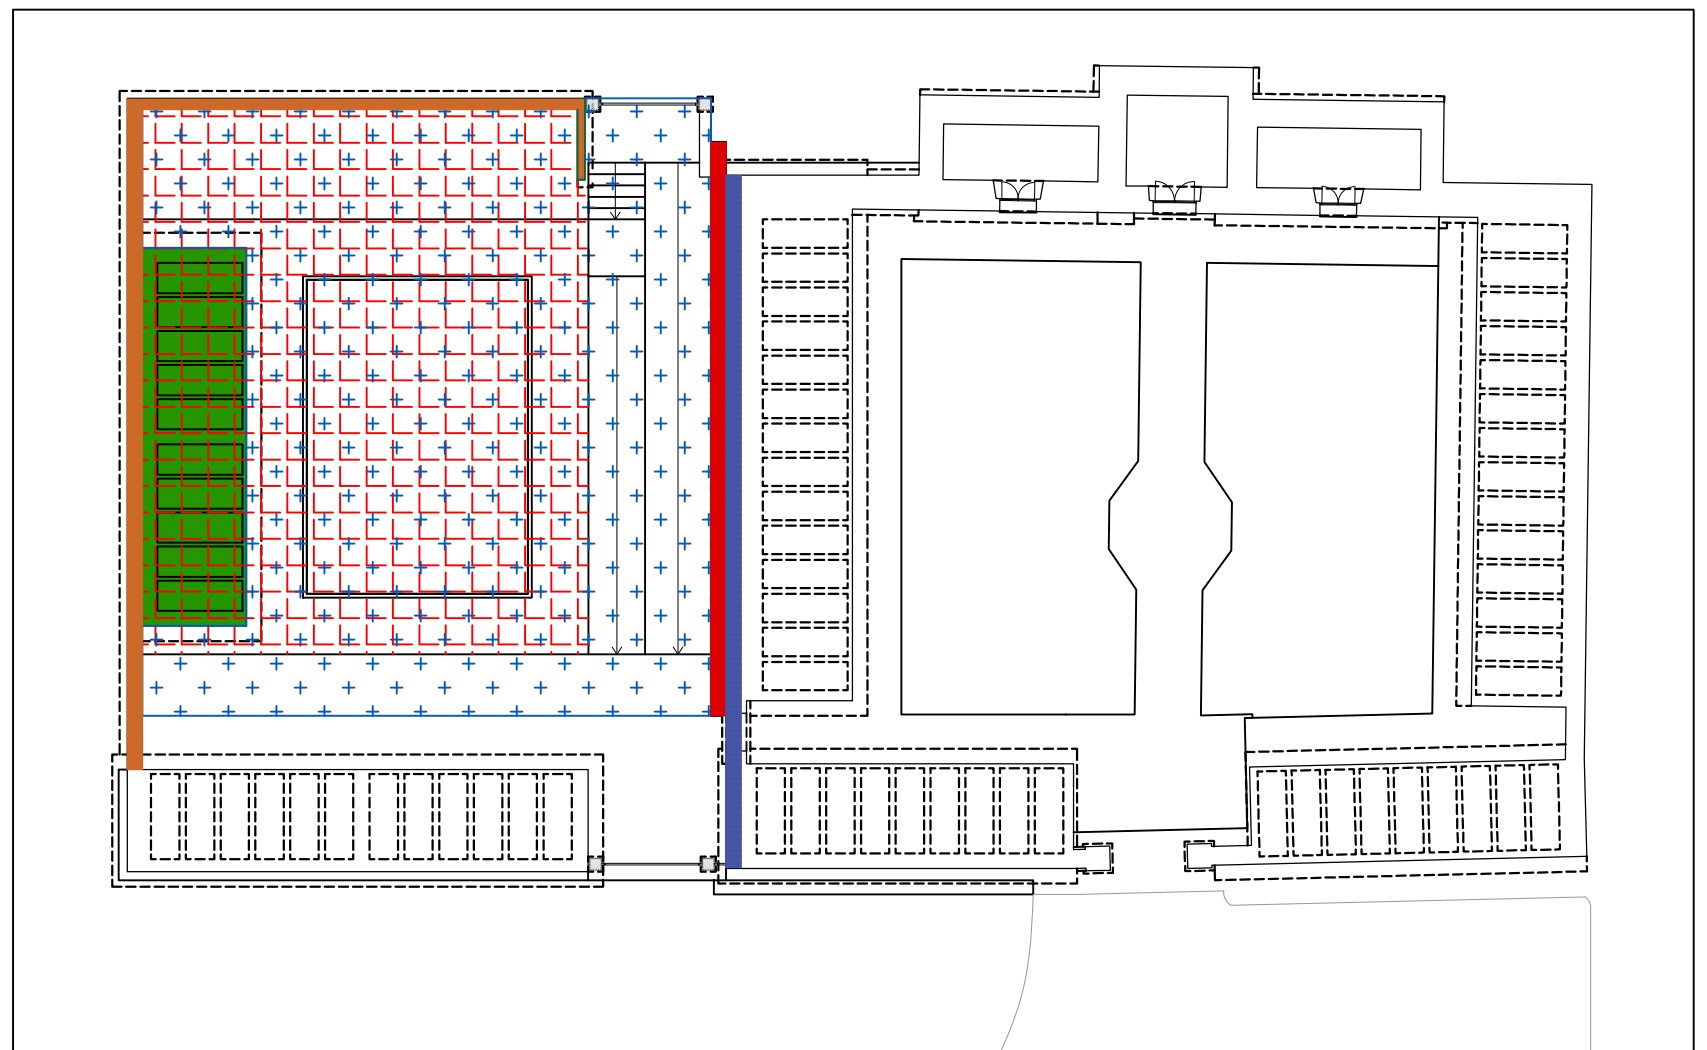


PROGETTO DEFINITIVO-ESECUTIVO

AMPLIAMENTO CIMITERO DI INTERMESOLI ALL'INTERNO DEL PERIMETRO ESISTENTE

STATO DI FATTO

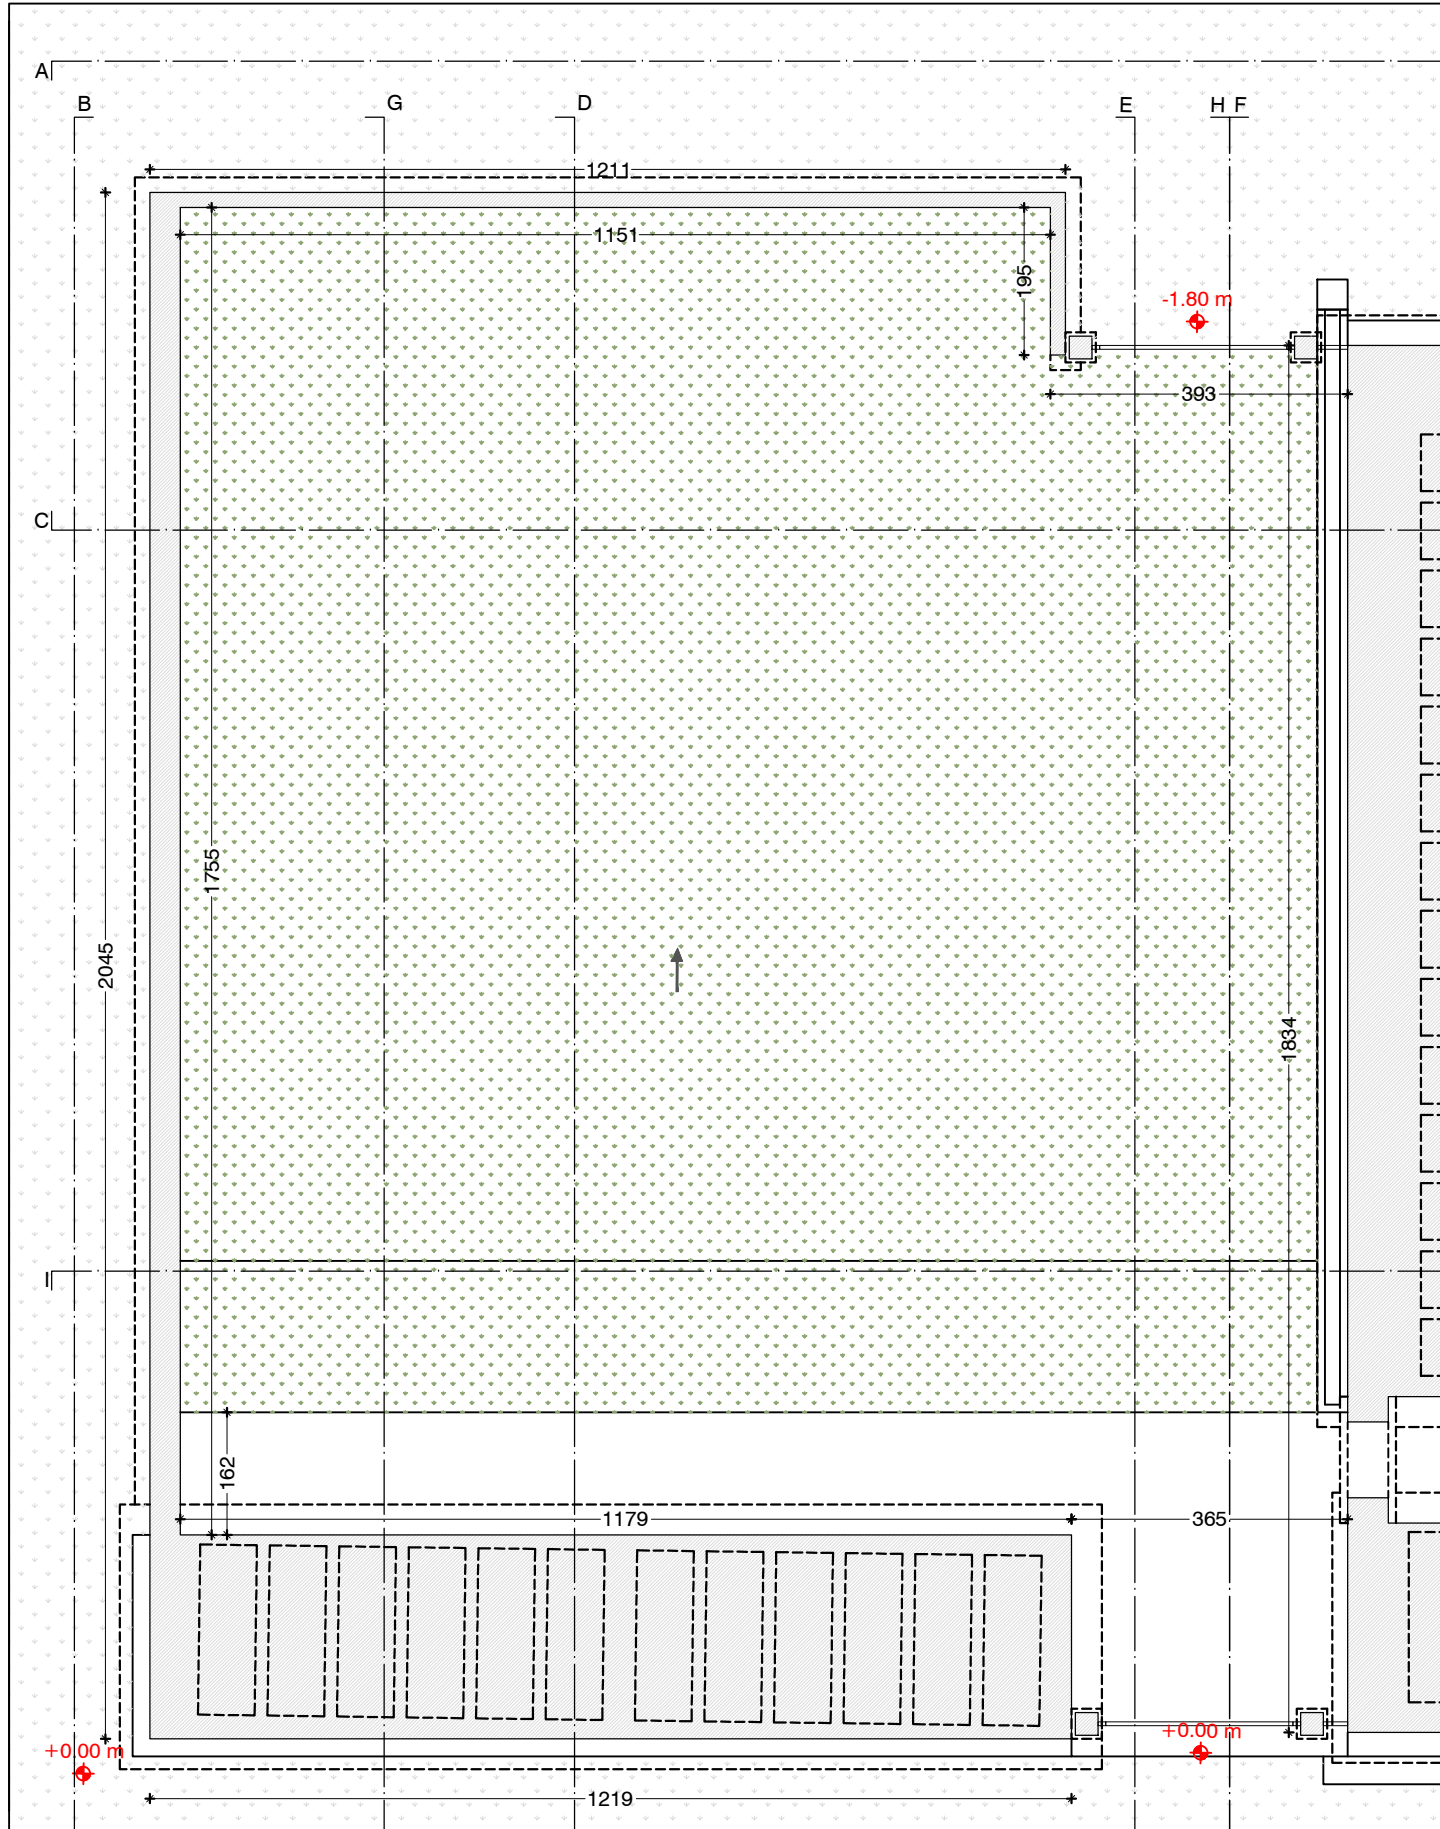

STATO DI PROGETTO

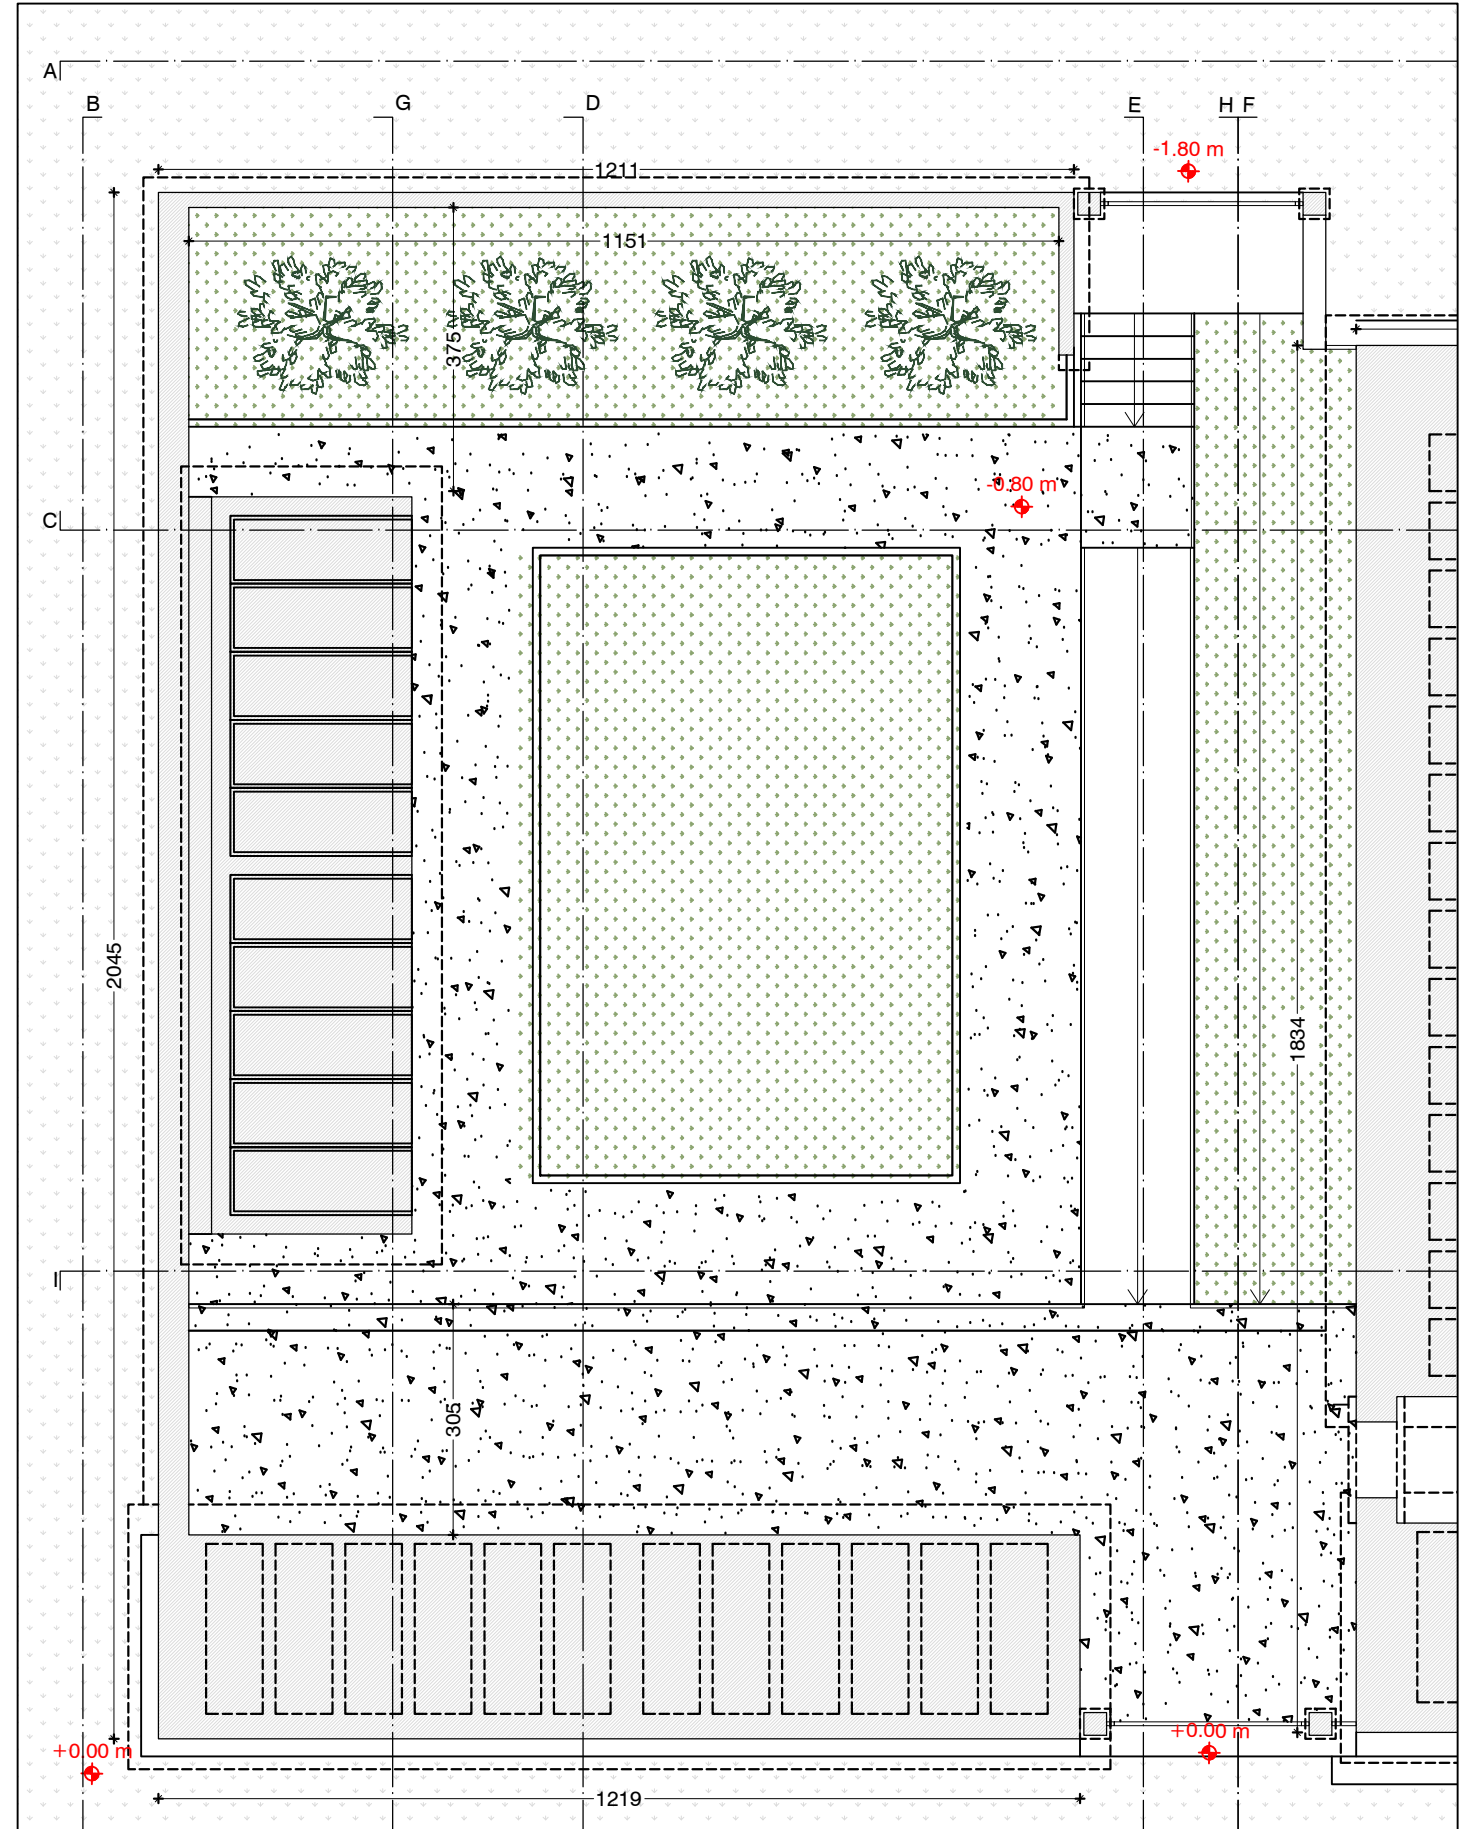


ELABORATO: PROGETTO ARCHITETTONICO_ PIANTA PIANO TERRA_ SCALA 1:100

TAV_07_2


PROGETTO DEFINITIVO-ESECUTIVO

AMPLIAMENTO CIMITERO DI INTERMESOLI ALL'INTERNO DEL PERIMETRO ESISTENTE

STATO DI FATTO

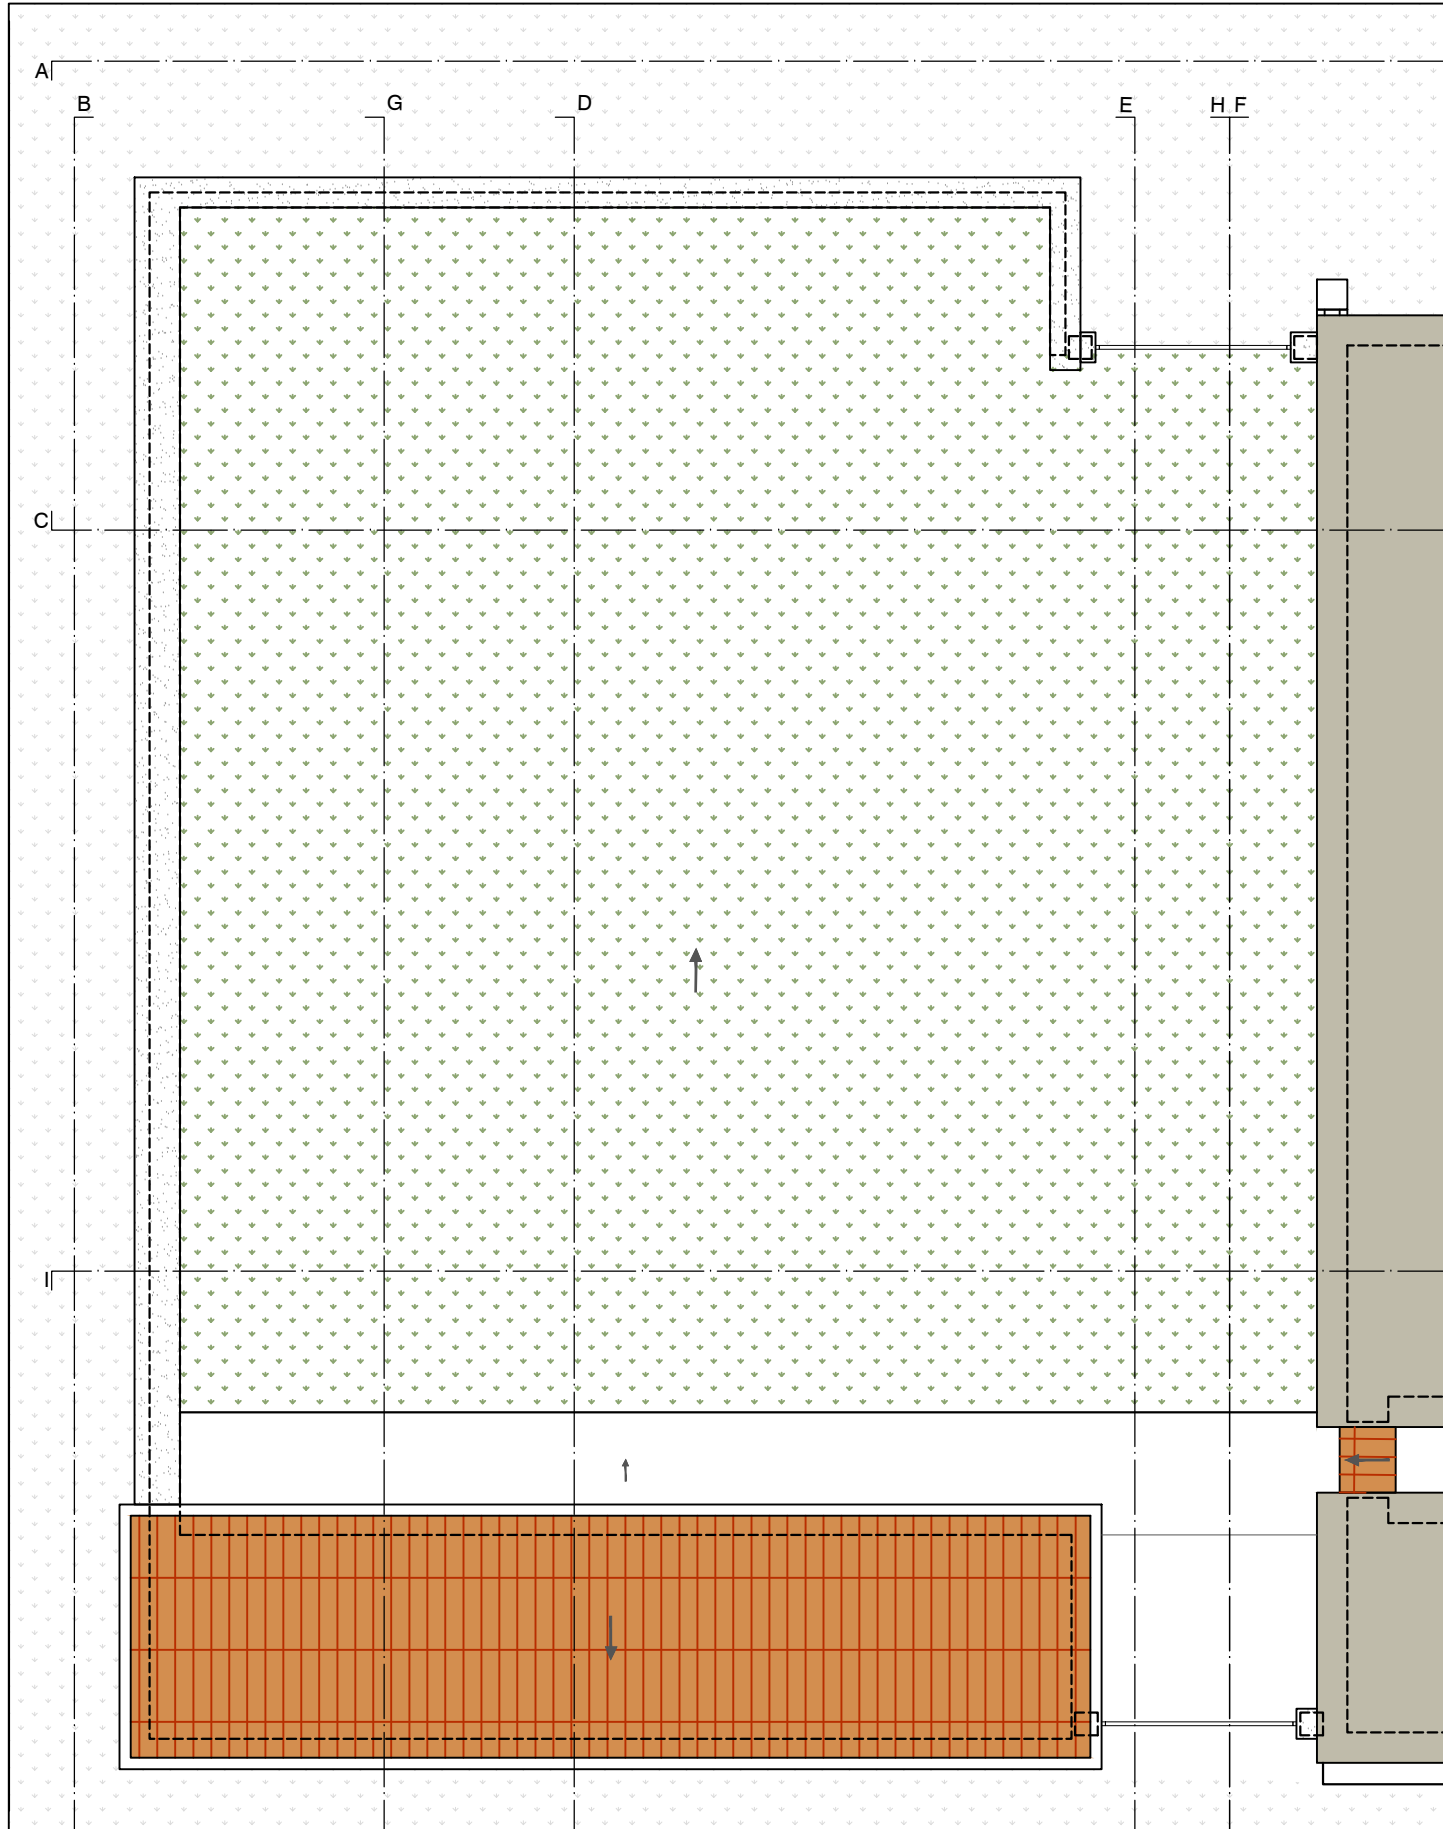

STATO DI PROGETTO

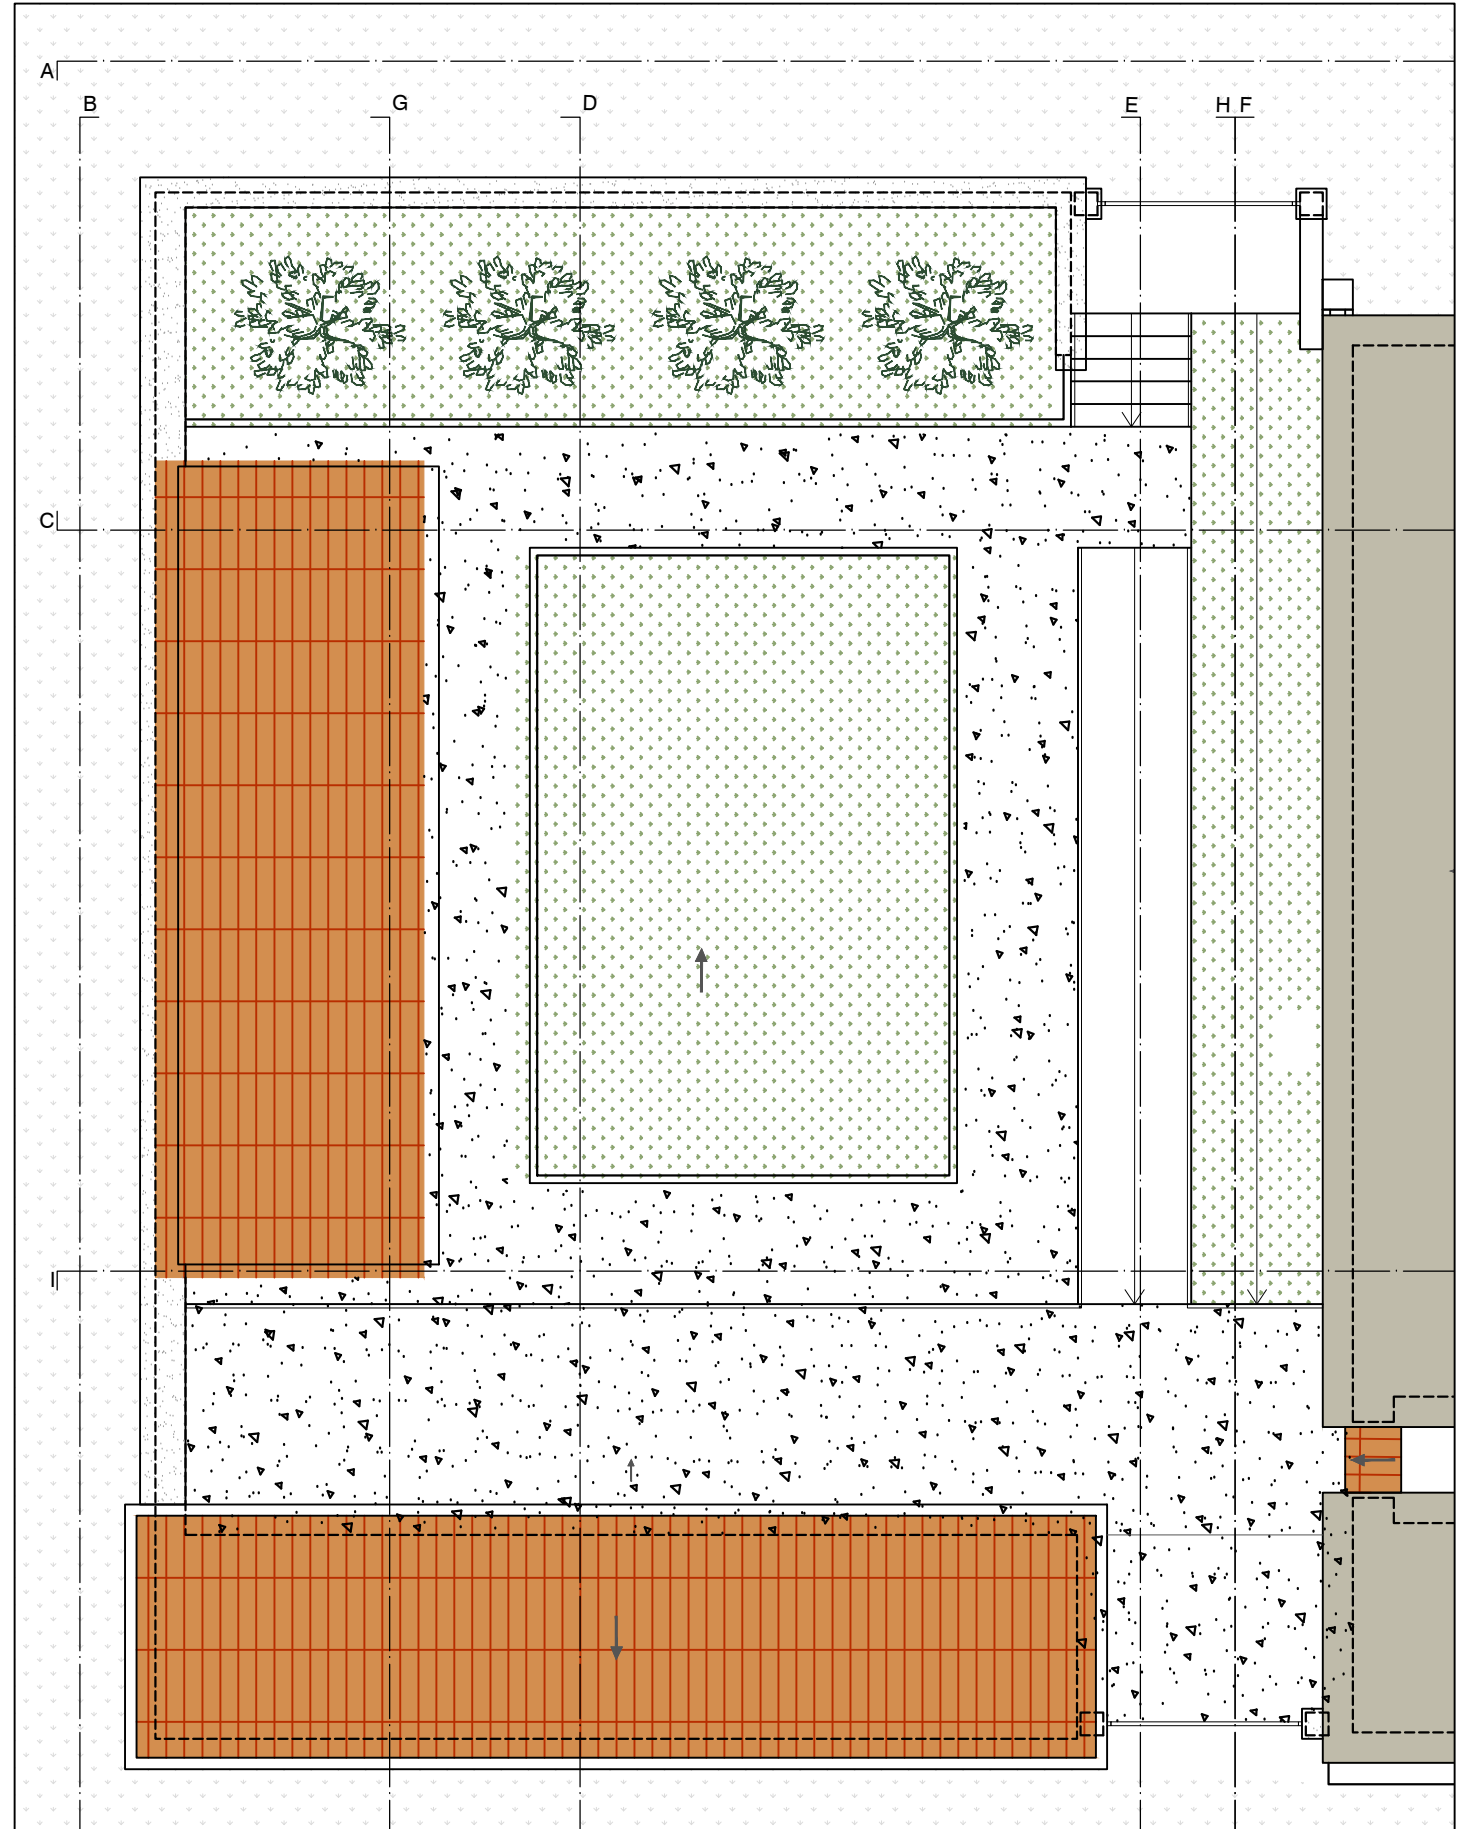


ELABORATO: PROGETTO ARCHITETTONICO_ PIANTA PIANO TERRA_ SCALA 1:100

TAV_07_3



CLAUDIA MORICONI INGEGNERE EDILE-ARCHITETTO - Via Risorgimento, 8 - 64044 Fano Adriano (TE)

Ing. Claudia Moriconi | P.I. 01867220673 | C.F. MRCCLD81L65H5011 | e-mail clamoriconi@gmail.com

STATO DI FATTO

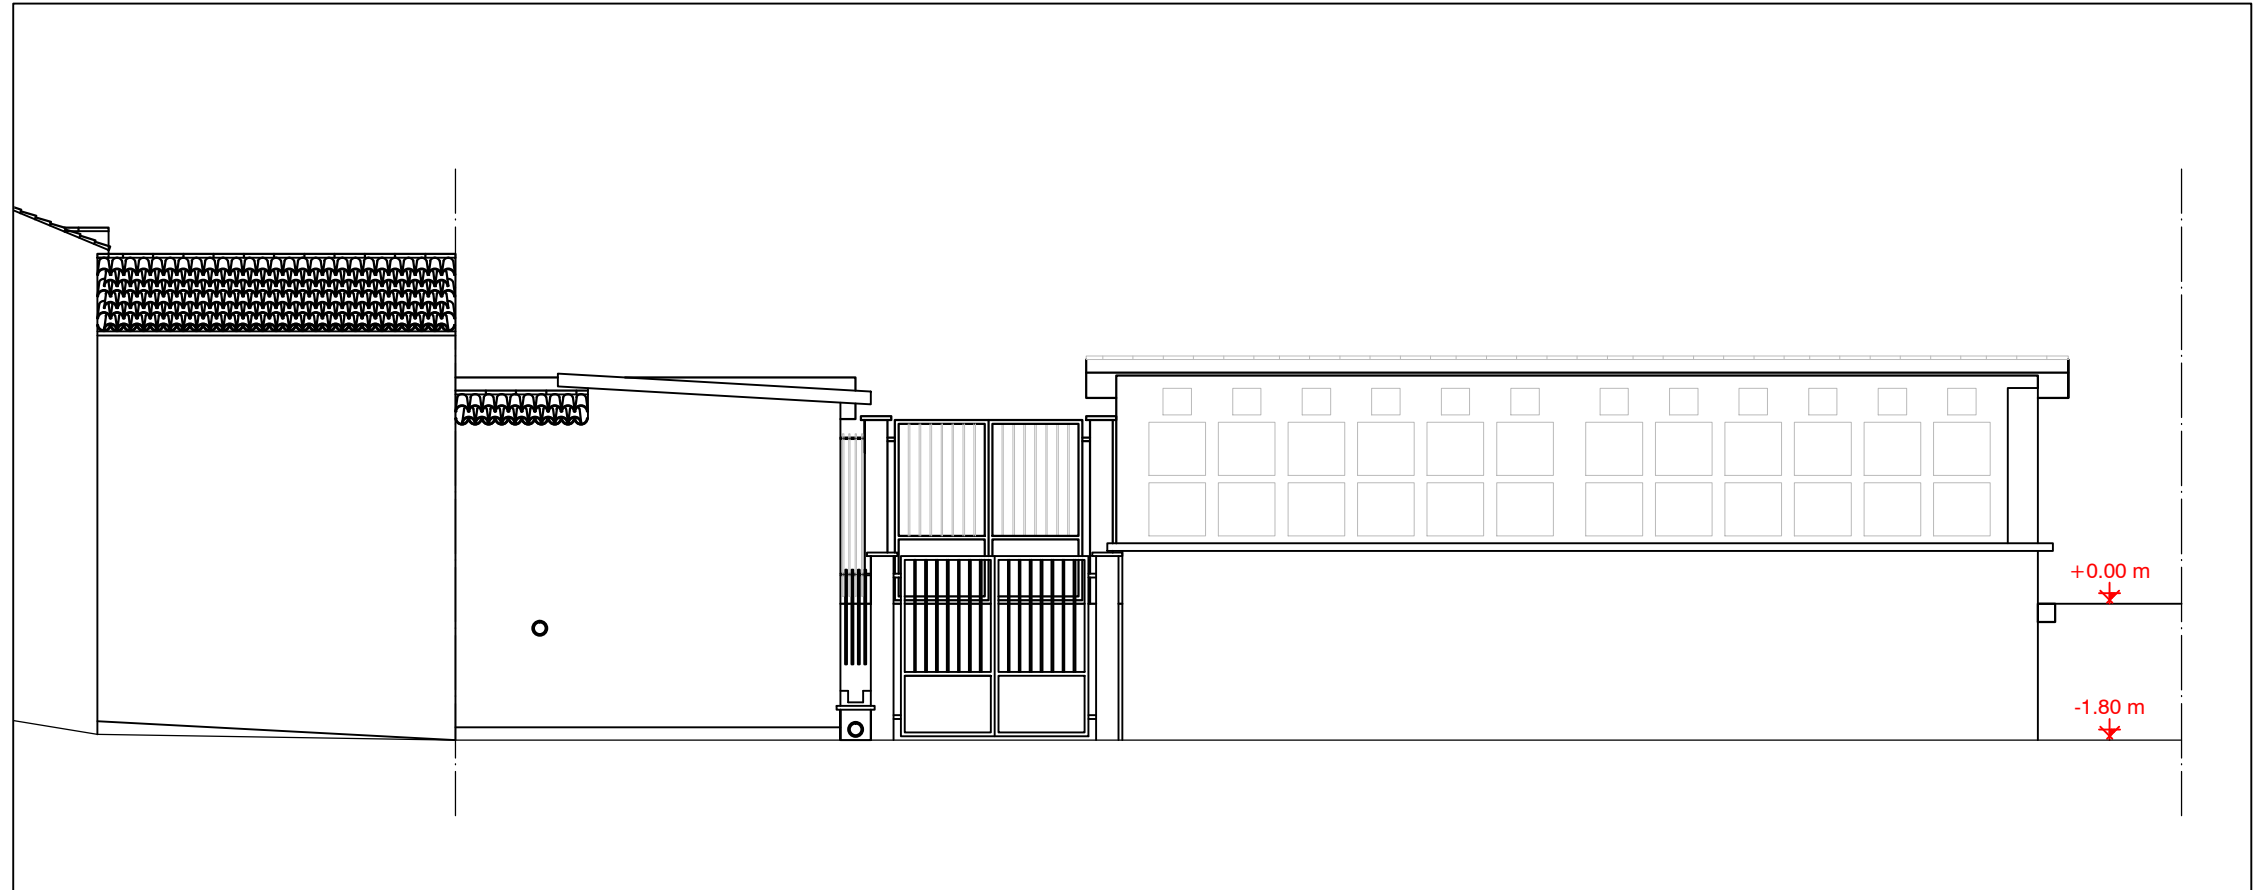

STATO DI PROGETTO

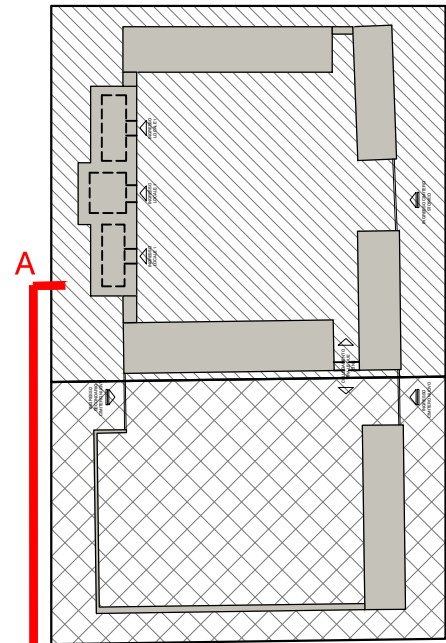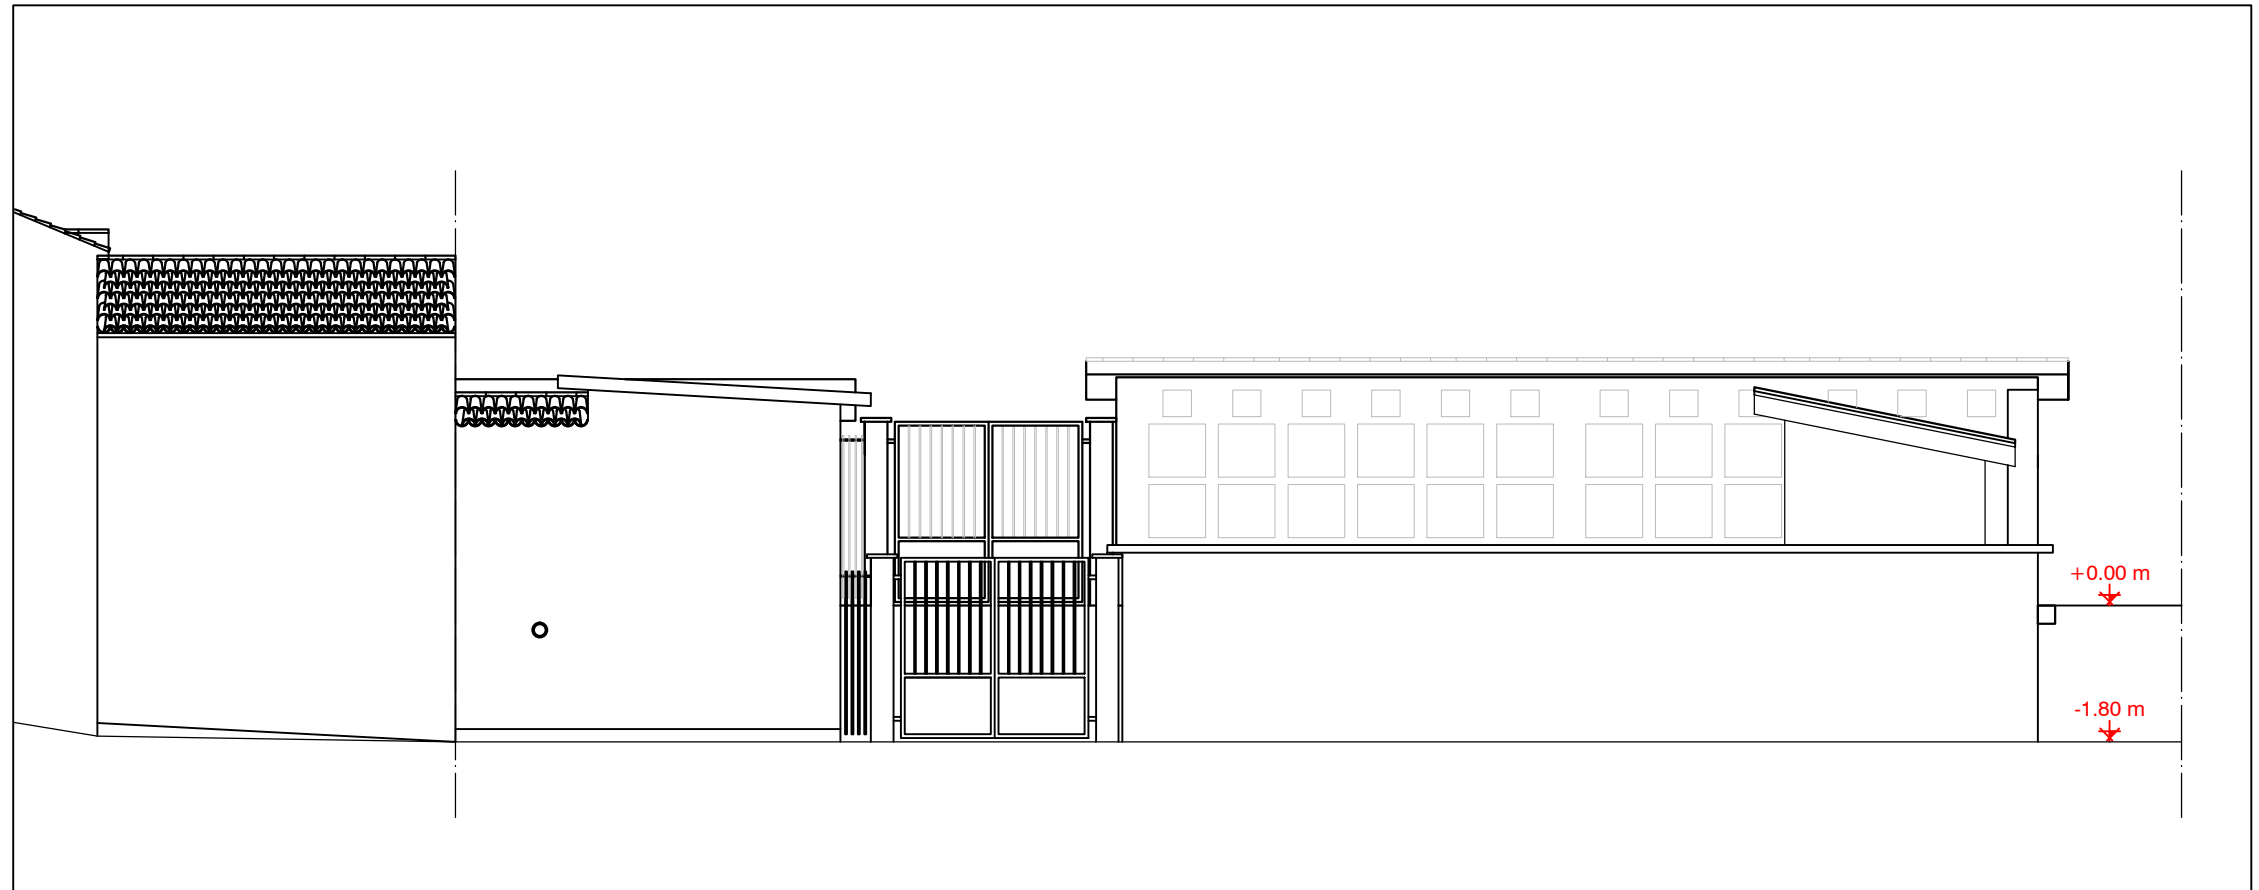


SCHEMA FUNZIONALE
scala 1:500



0 5 10 50



STATO DI FATTO

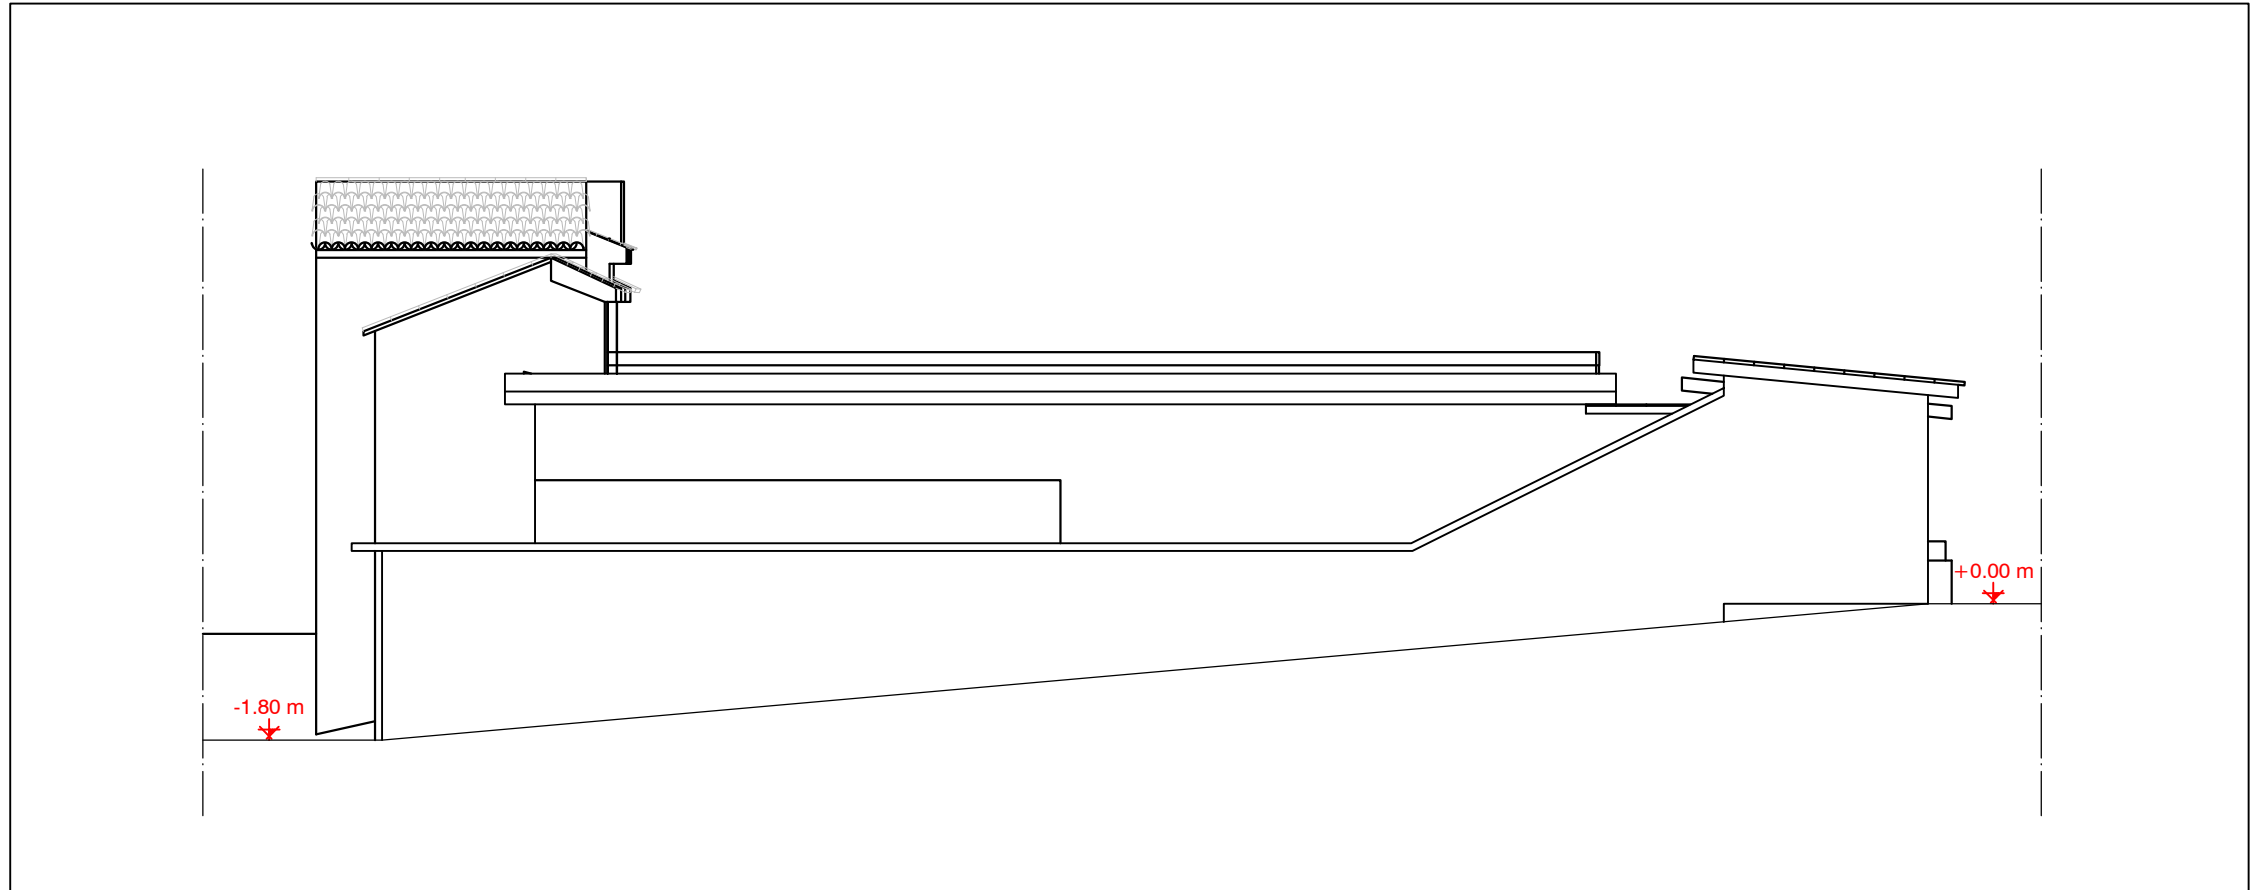

STATO DI PROGETTO

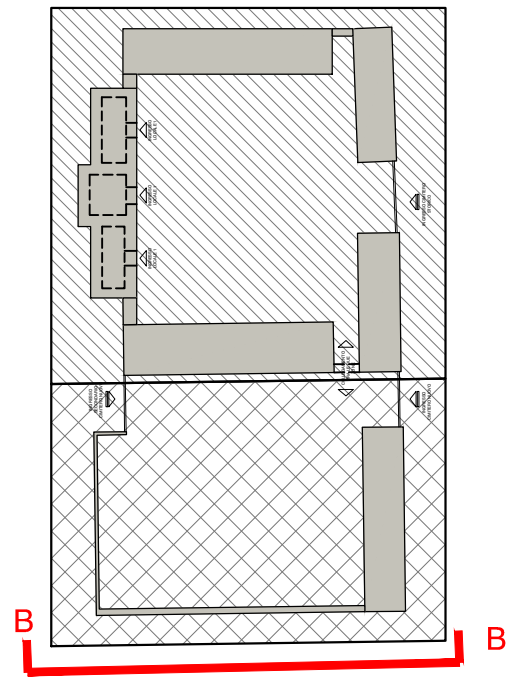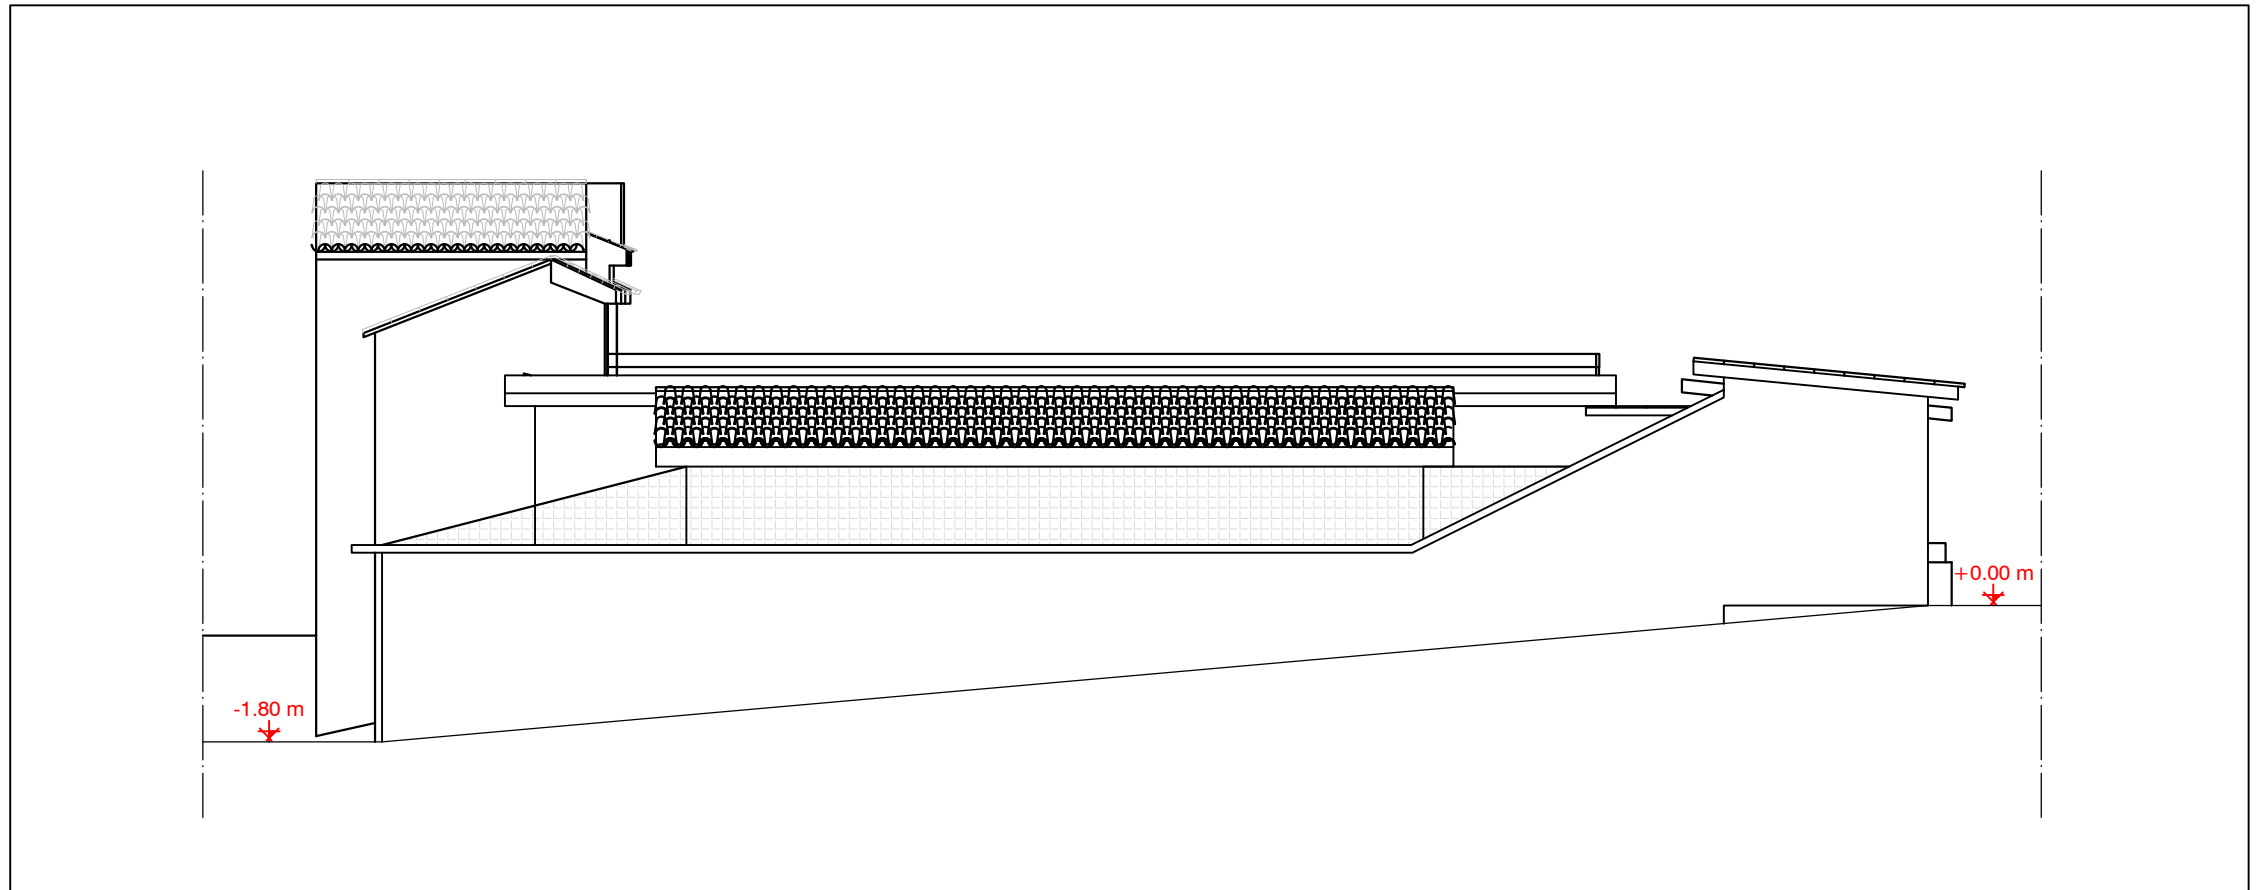


SCHEMA FUNZIONALE
scala 1:500



0 5 10 50



STATO DI FATTO

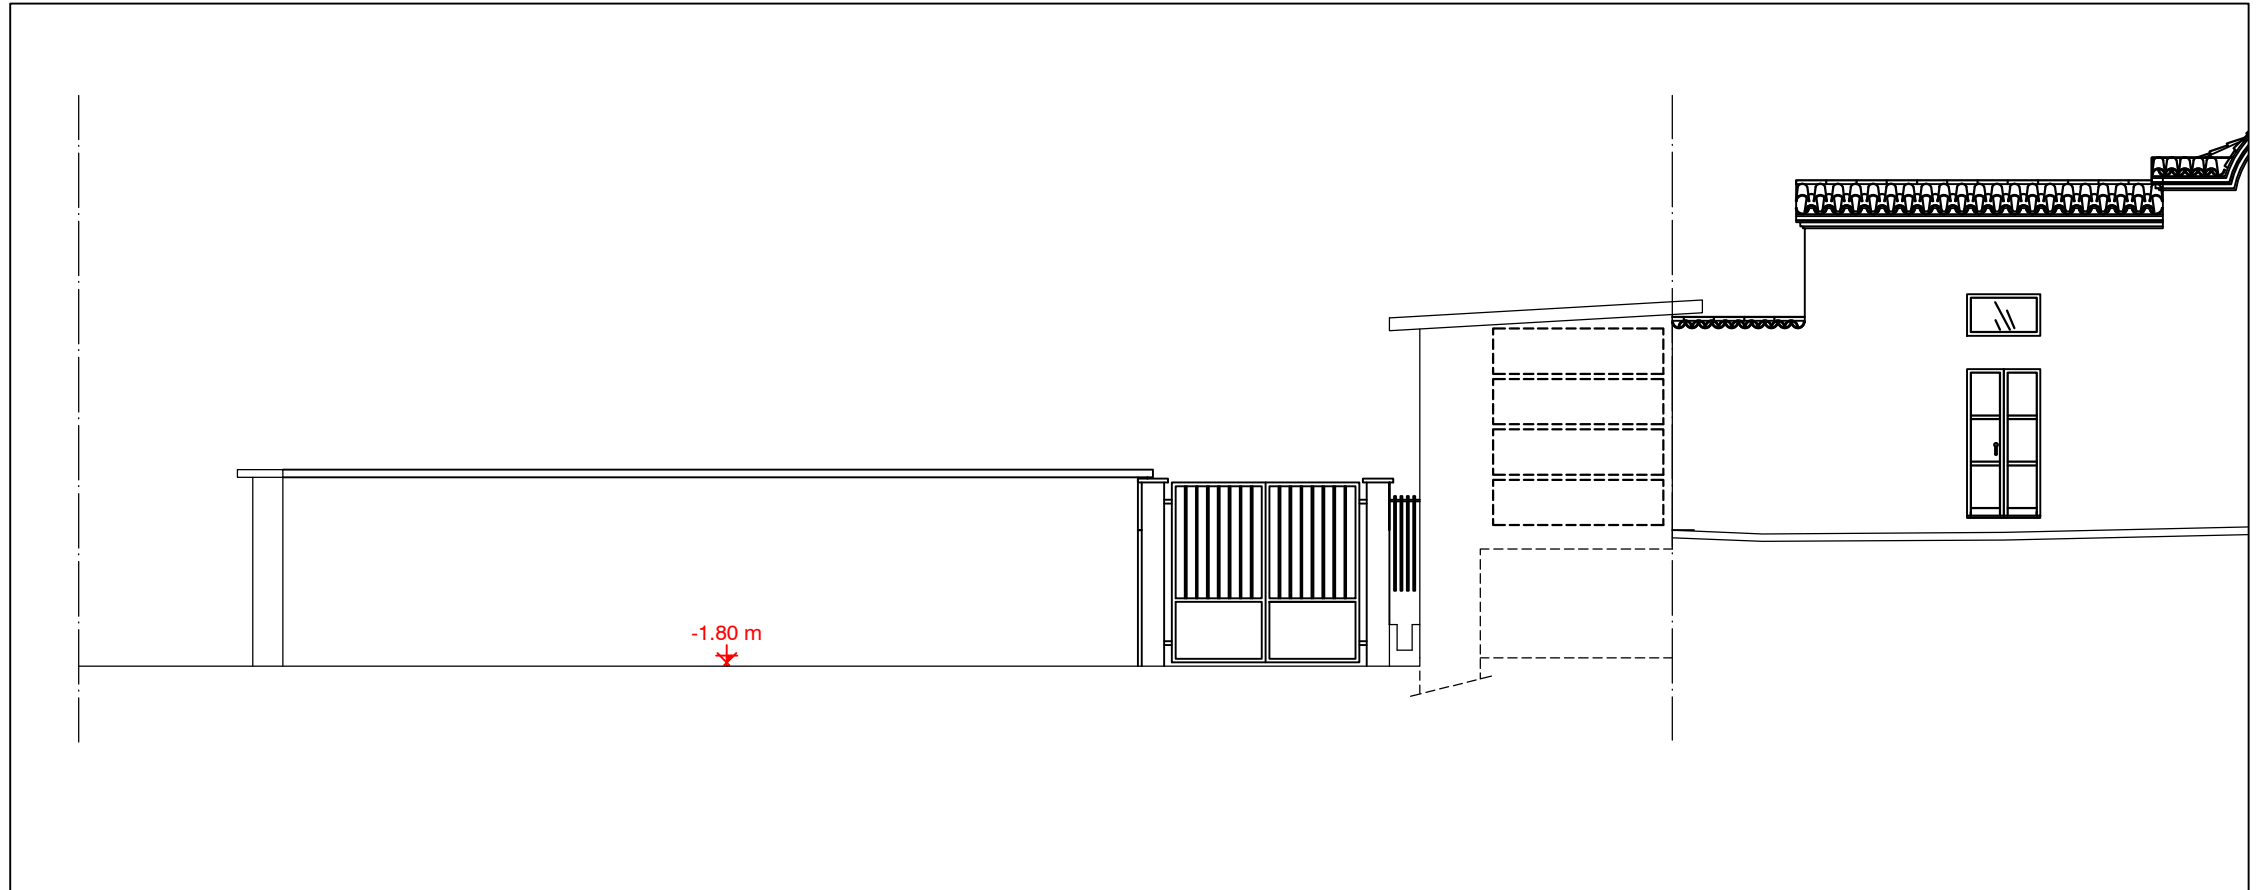

STATO DI PROGETTO

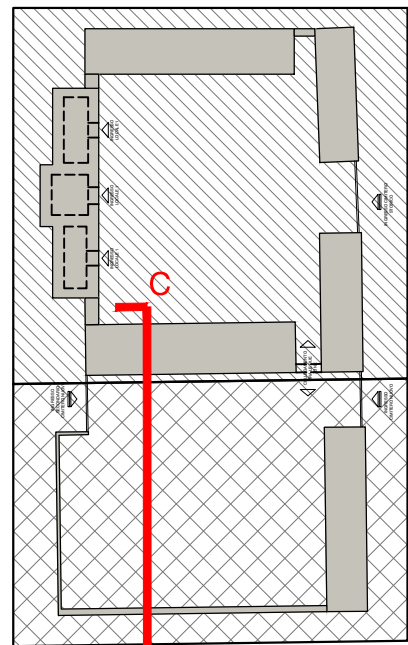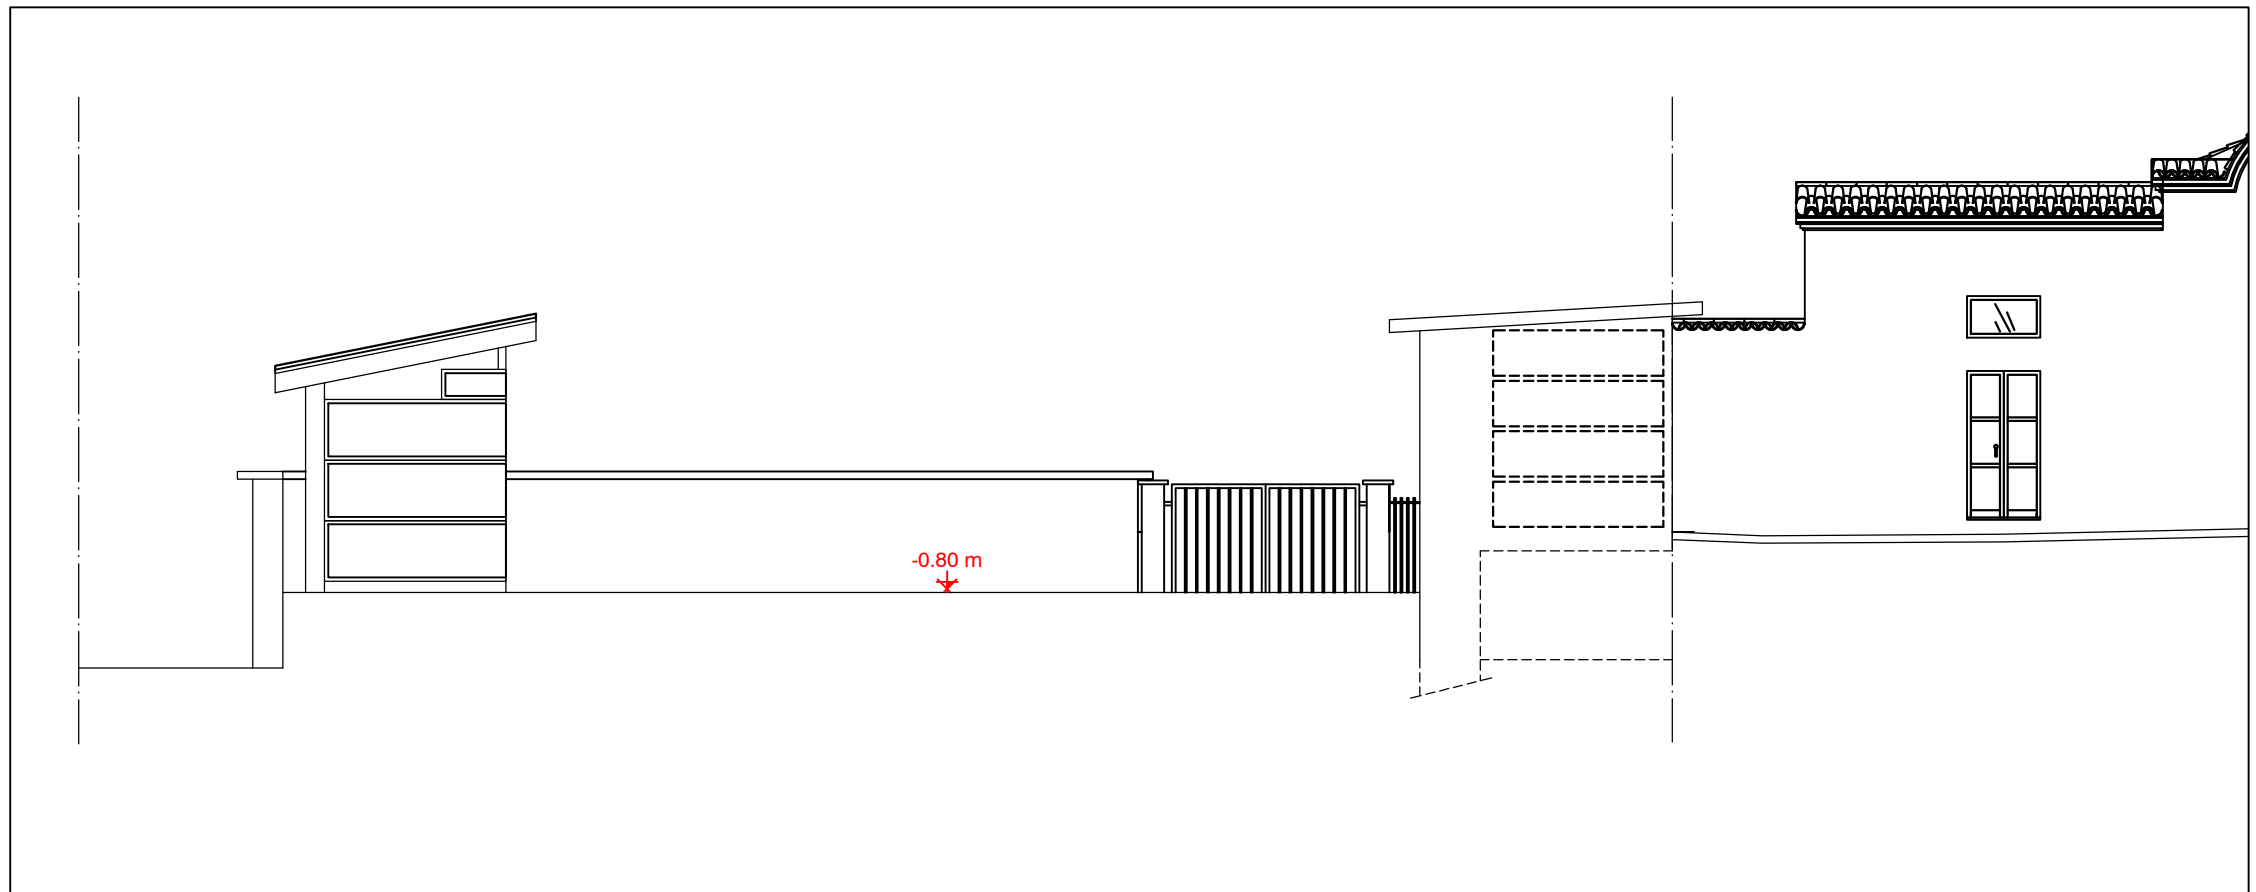


SCHEMA FUNZIONALE
scala 1:500



0 5 10 50



STATO DI FATTO

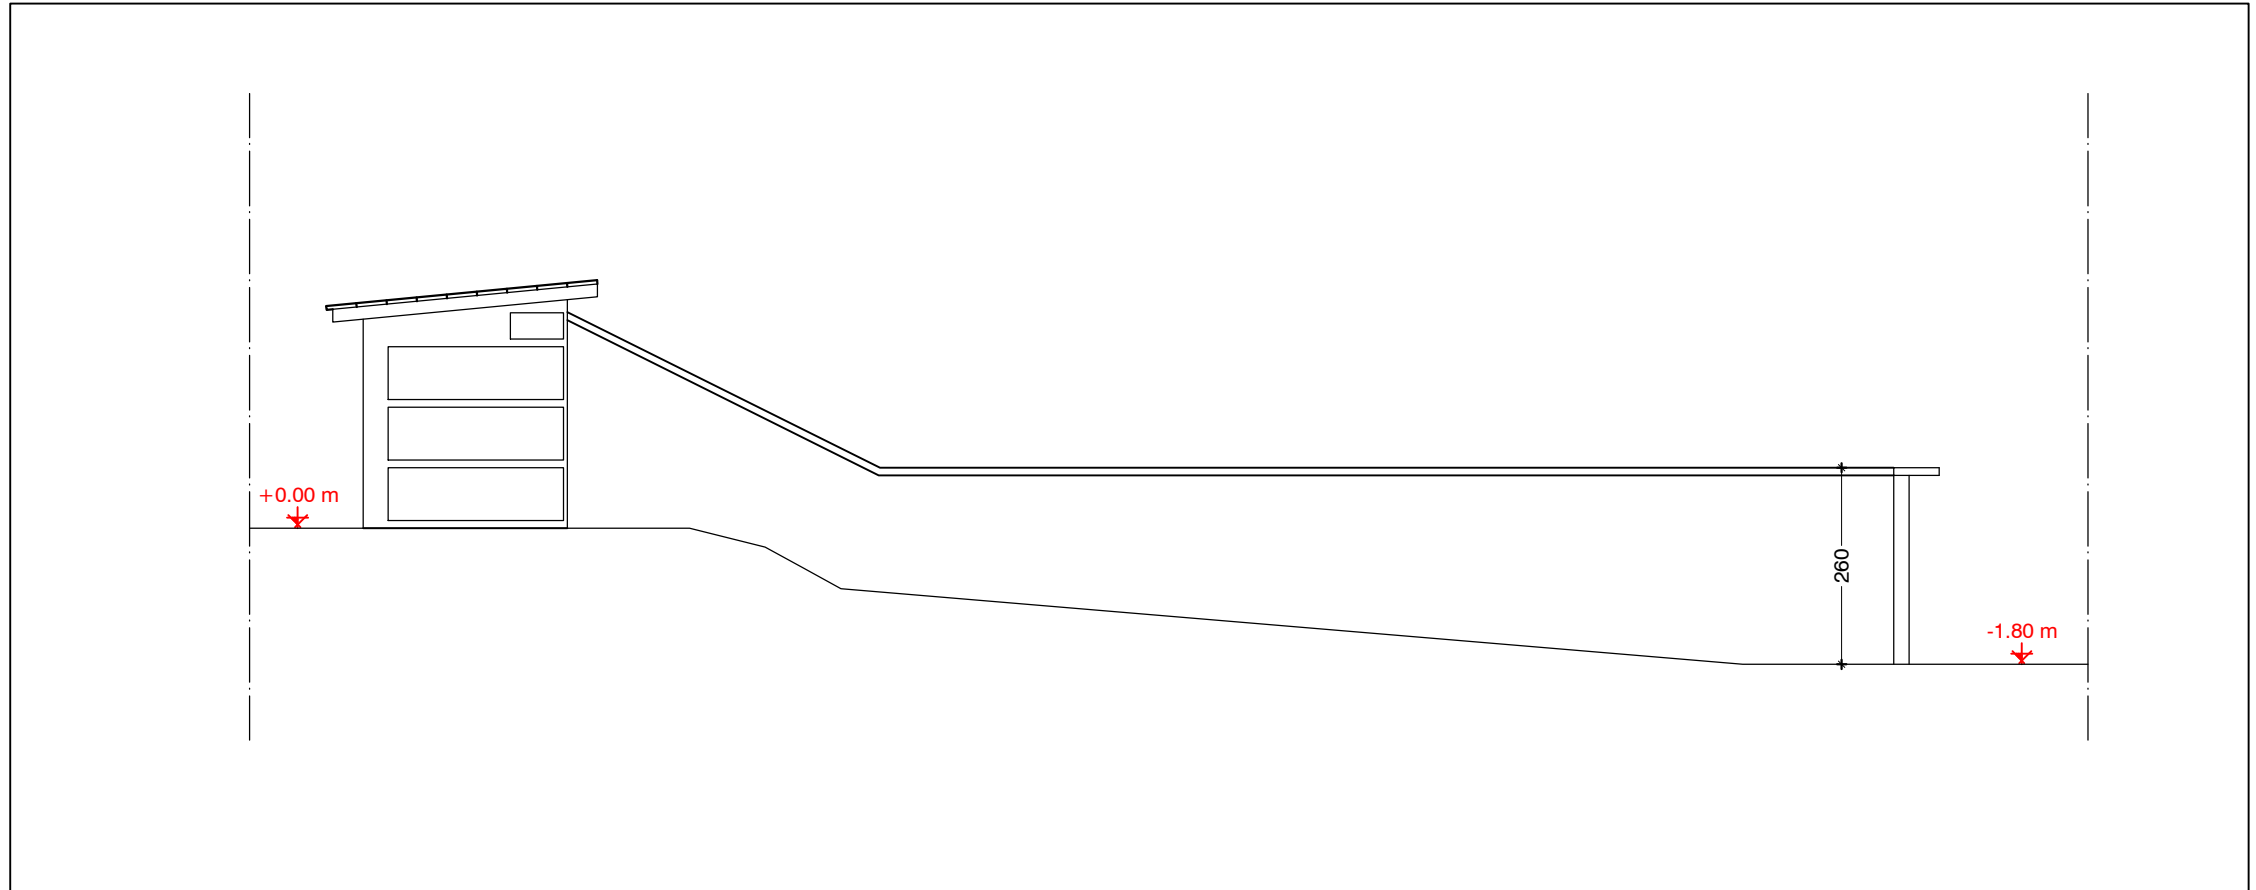

STATO DI PROGETTO

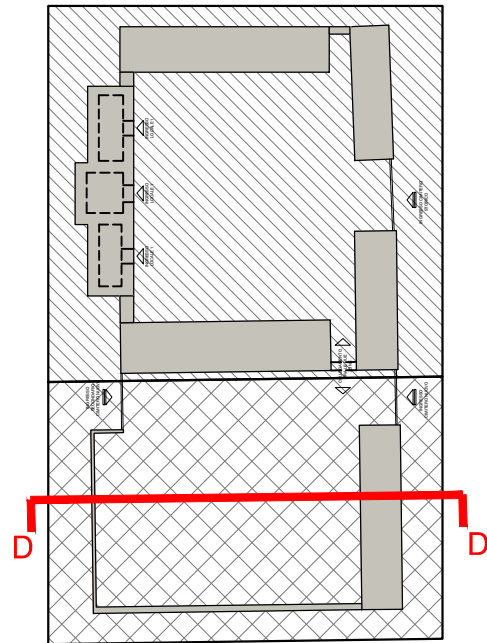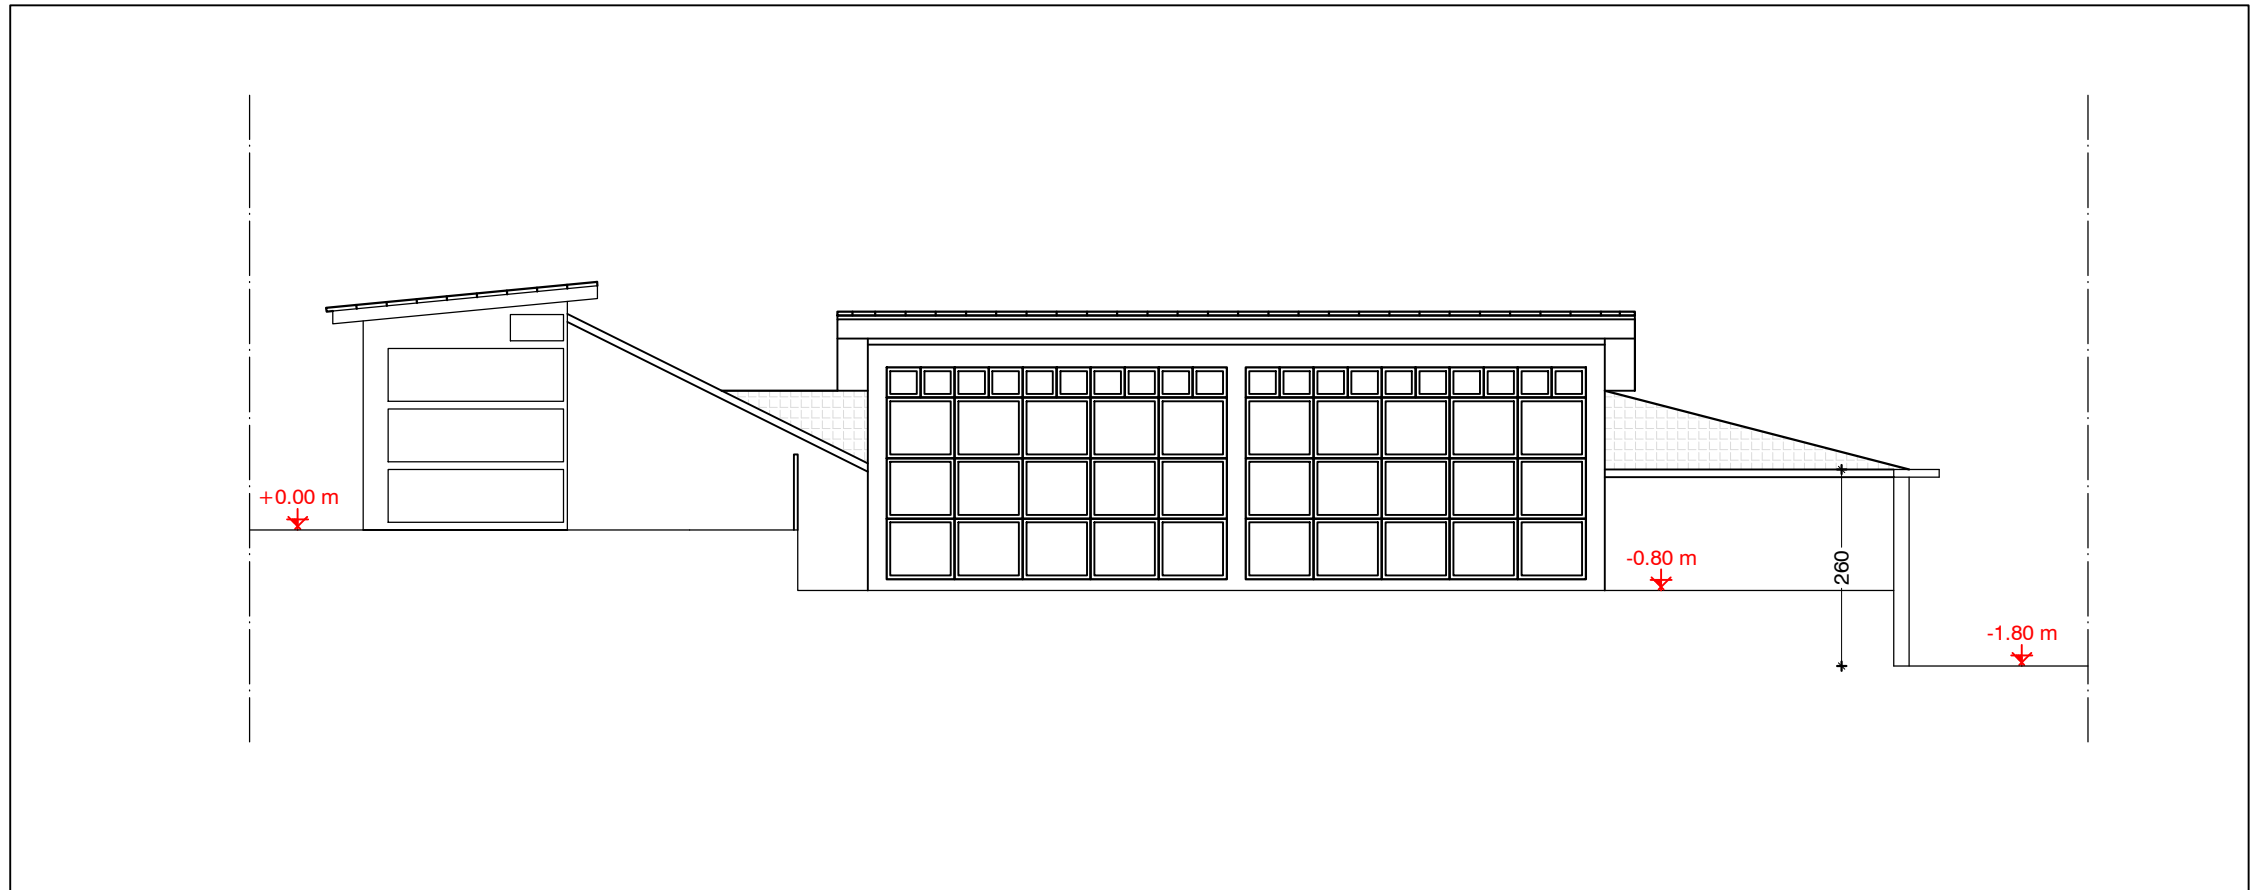


SCHEMA FUNZIONALE
scala 1:500



0 5 10 50



STATO DI FATTO

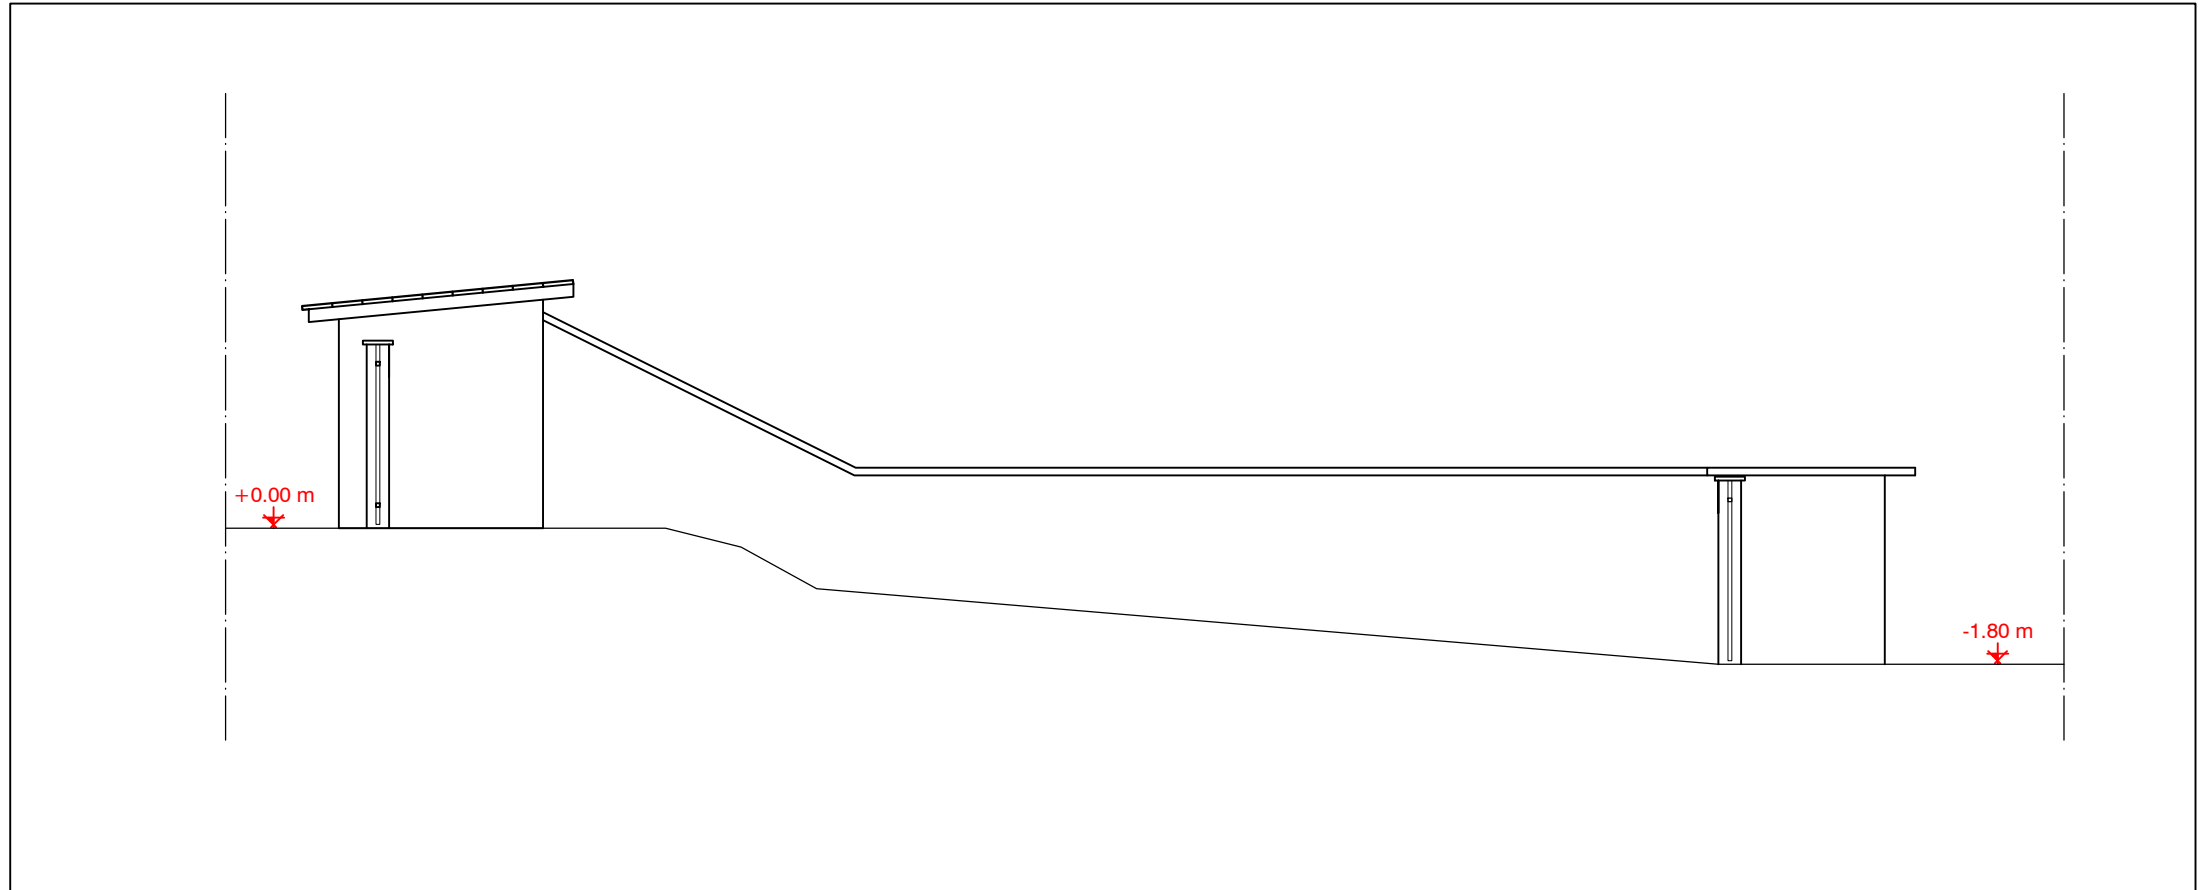

STATO DI PROGETTO

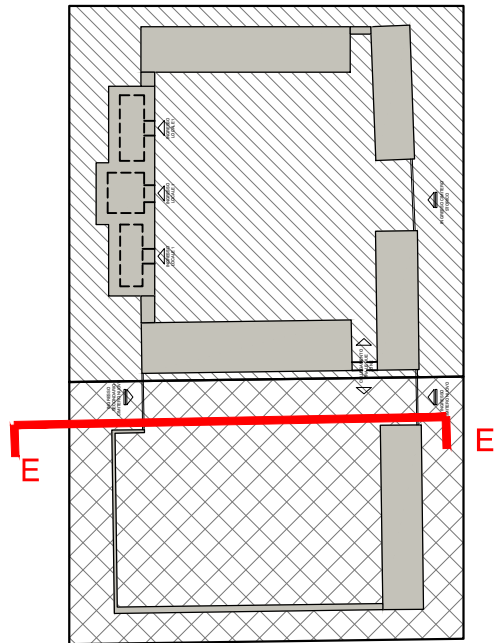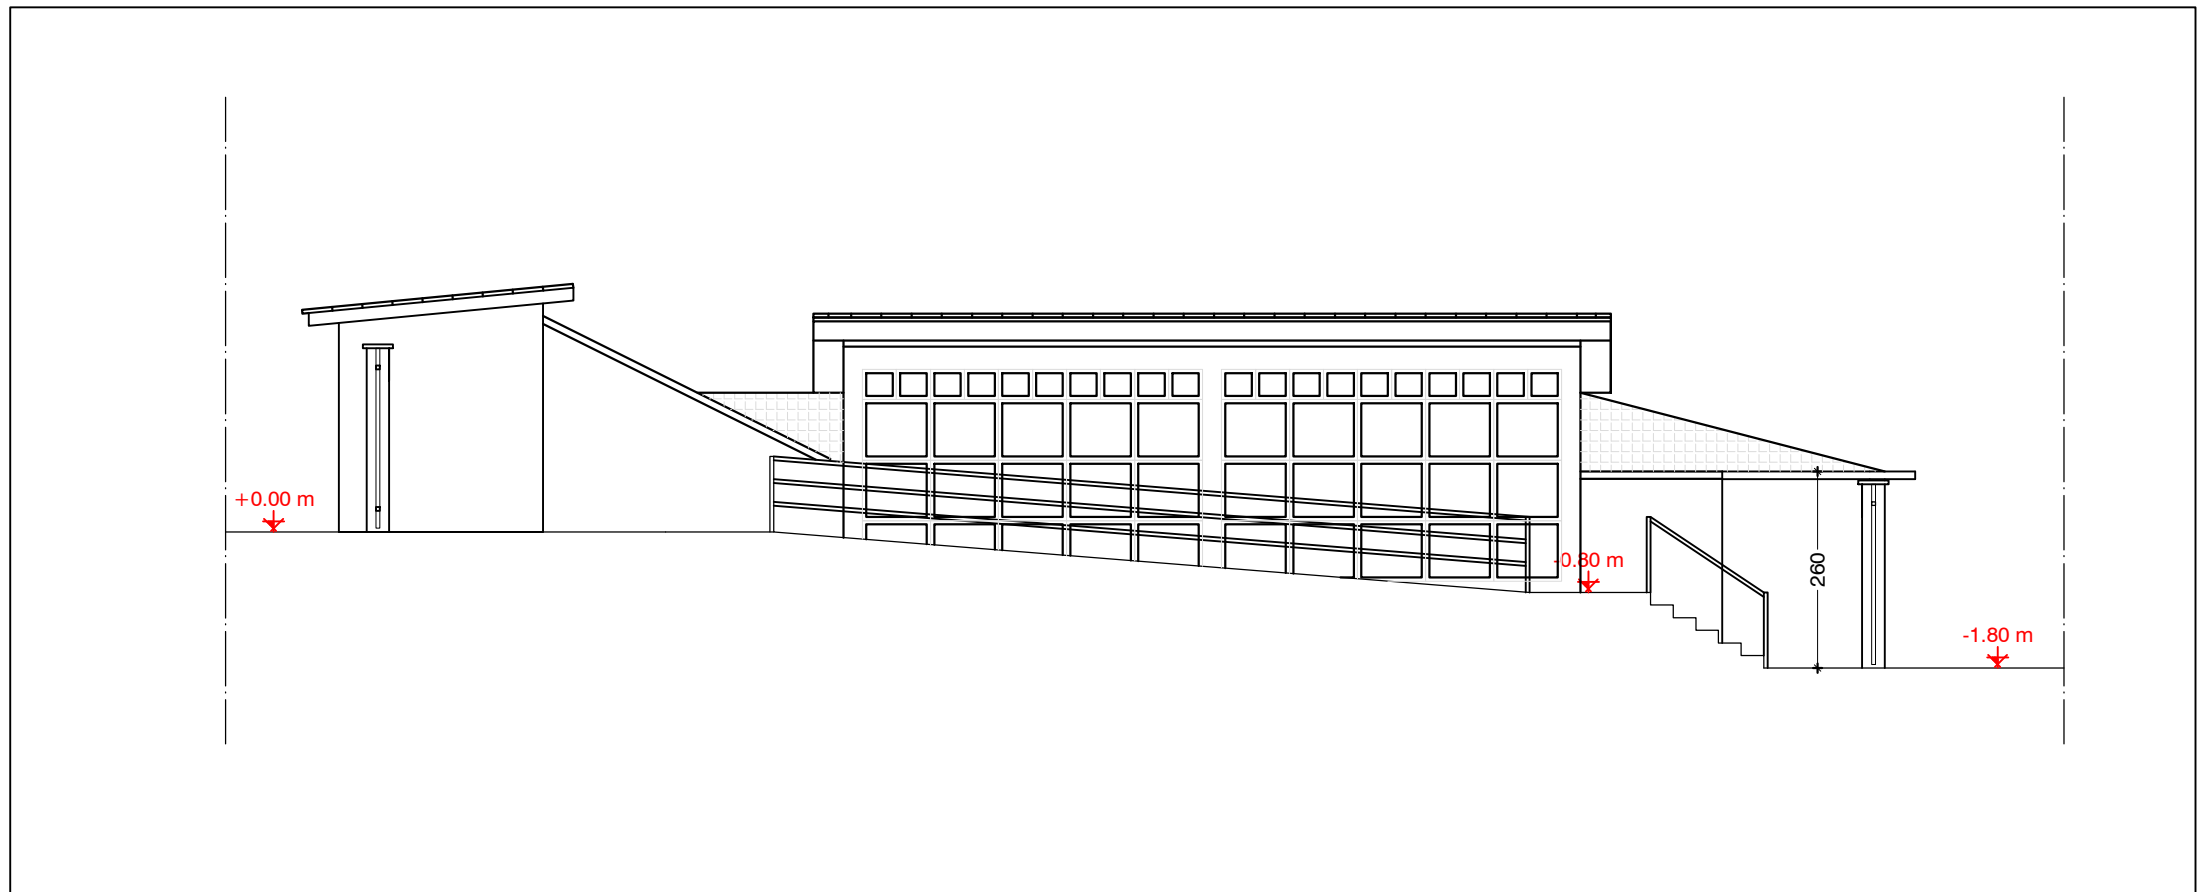


SCHEMA FUNZIONALE
scala 1:500



0 5 10 50



STATO DI FATTO

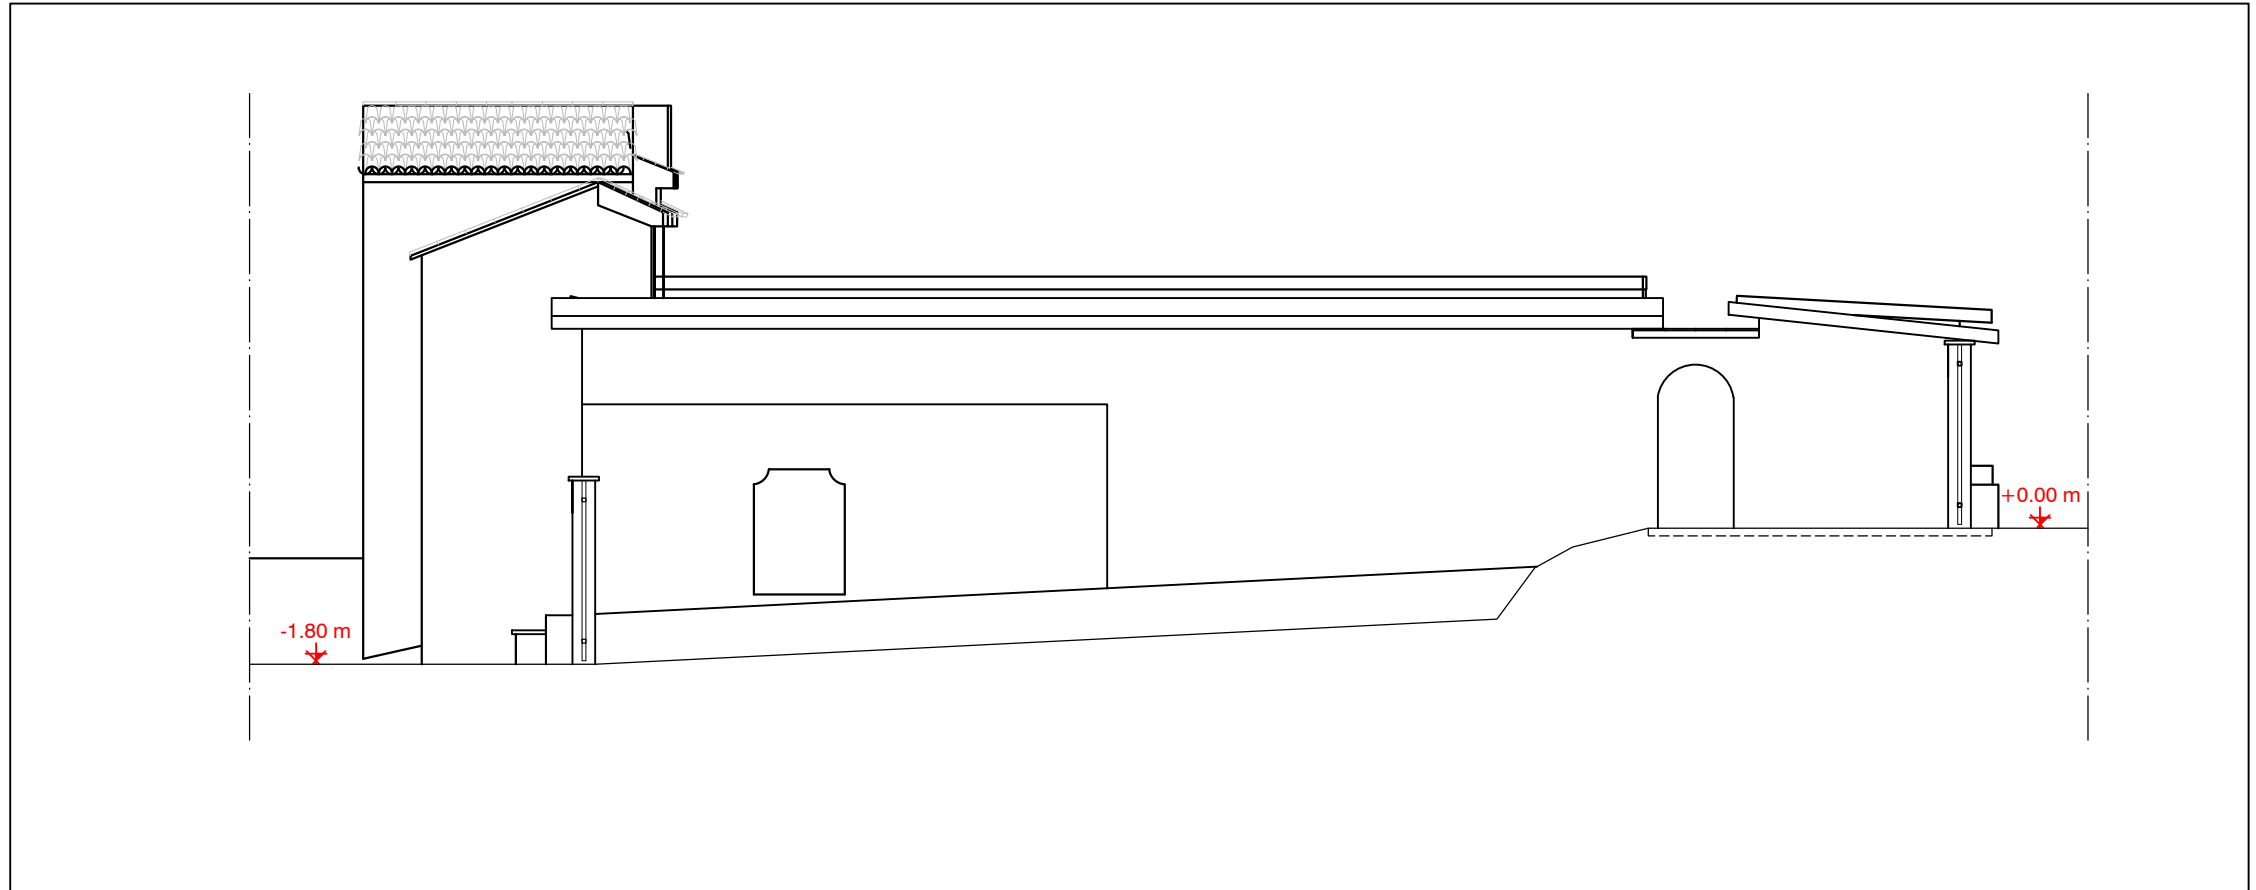

STATO DI PROGETTO

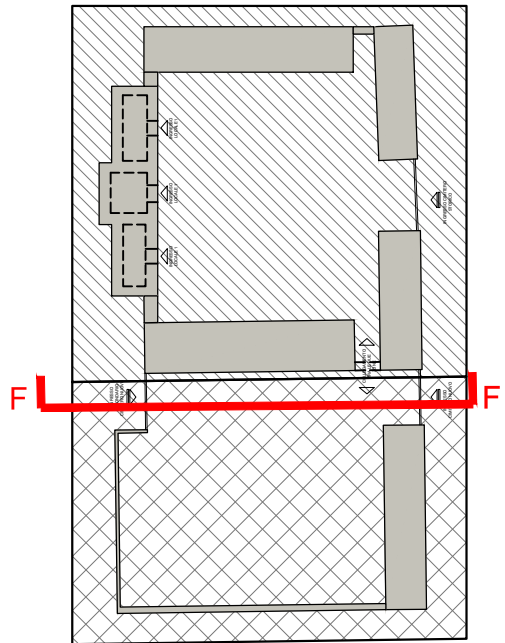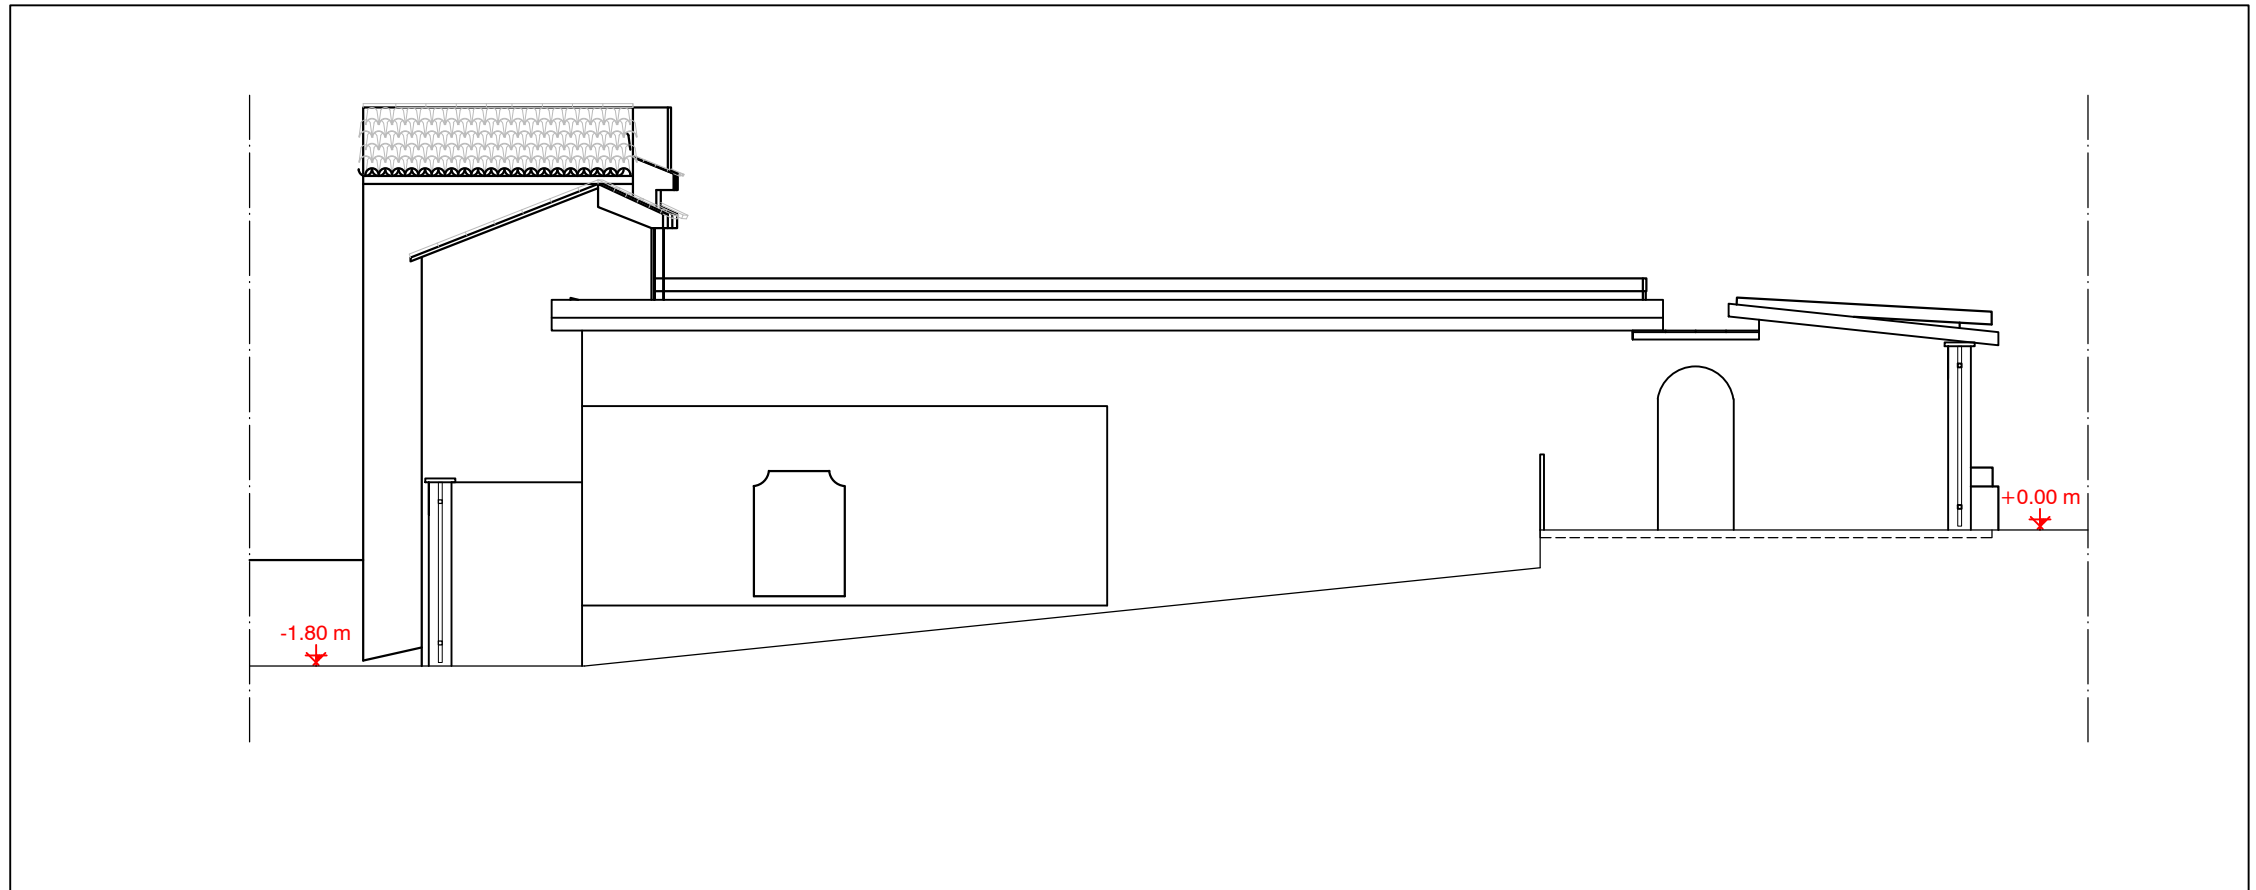


SCHEMA FUNZIONALE
scala 1:500



0 5 10 50



STATO DI FATTO

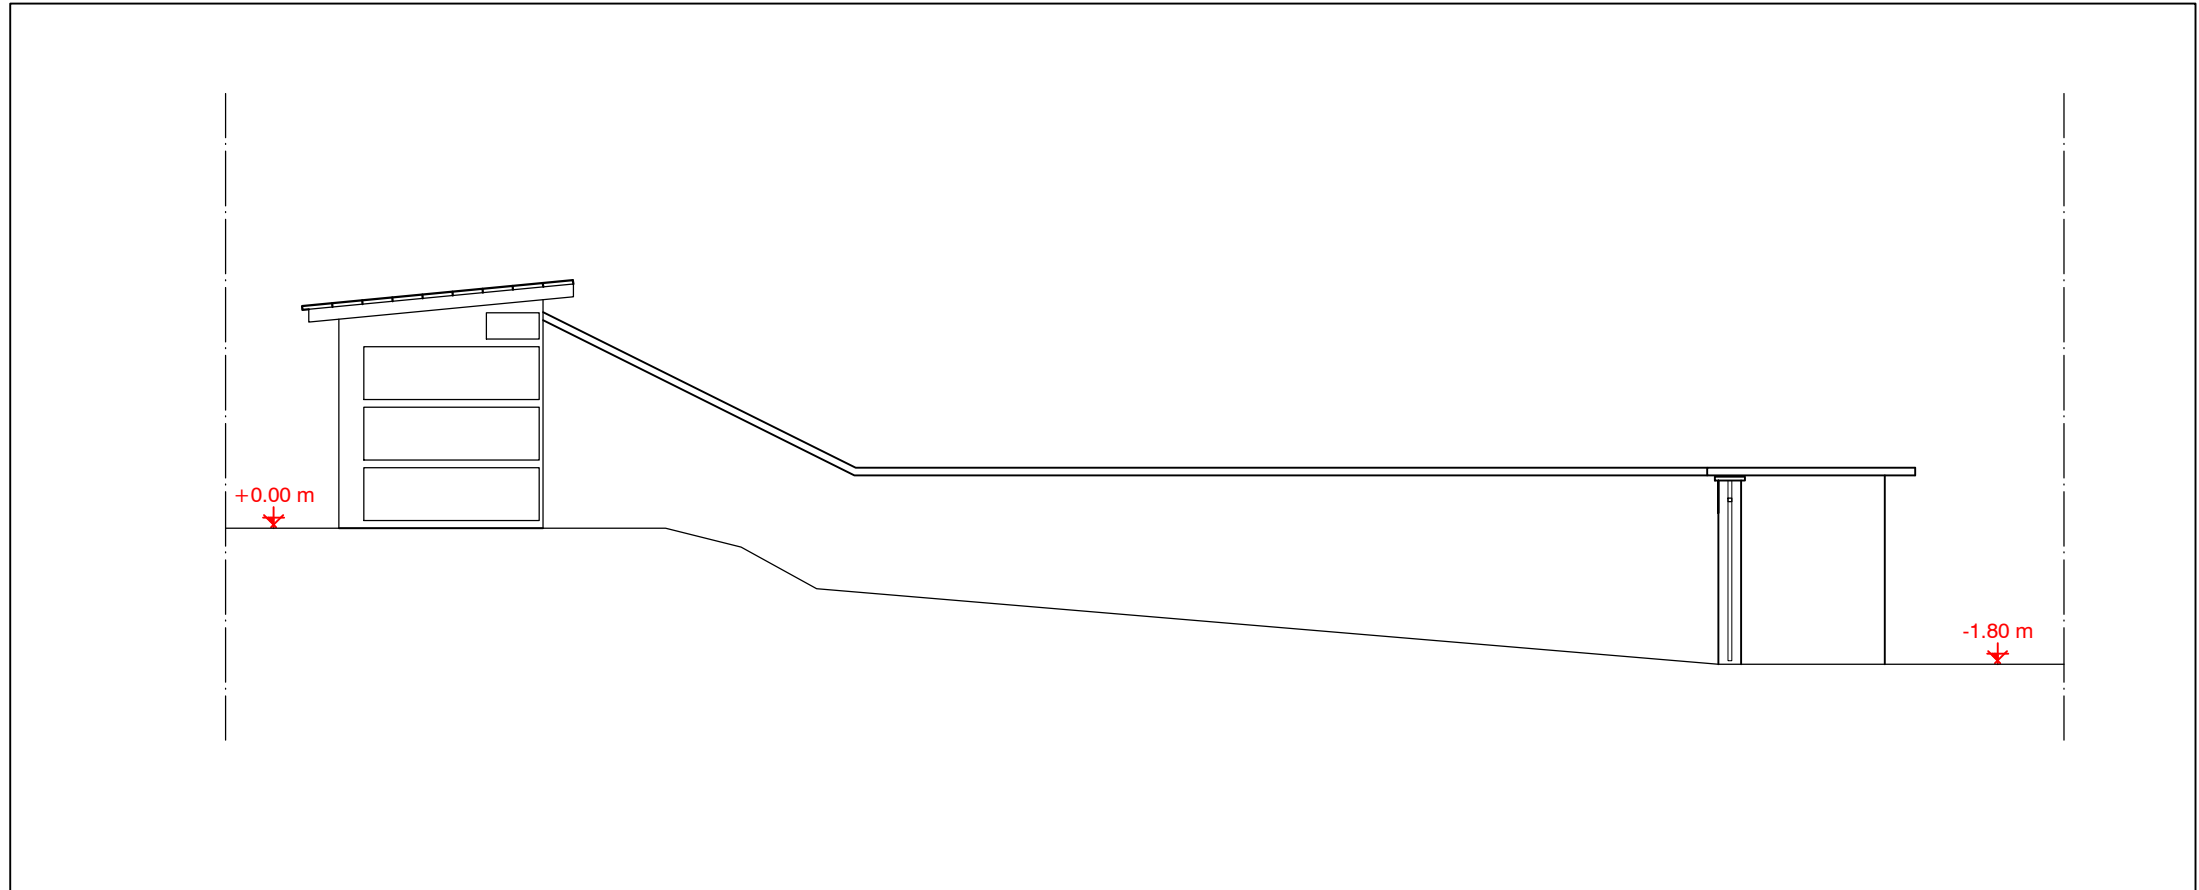

STATO DI PROGETTO

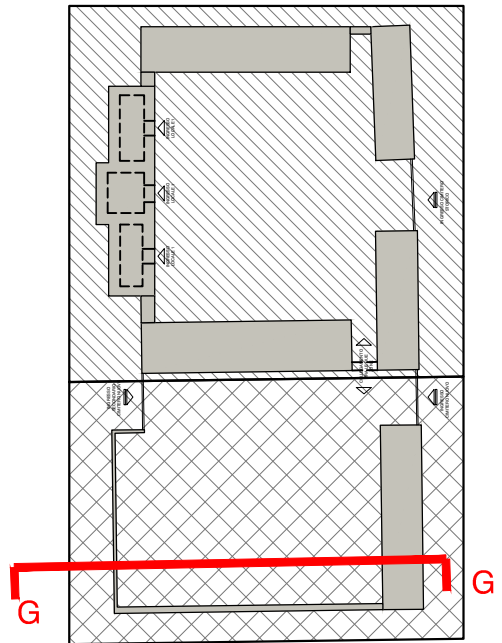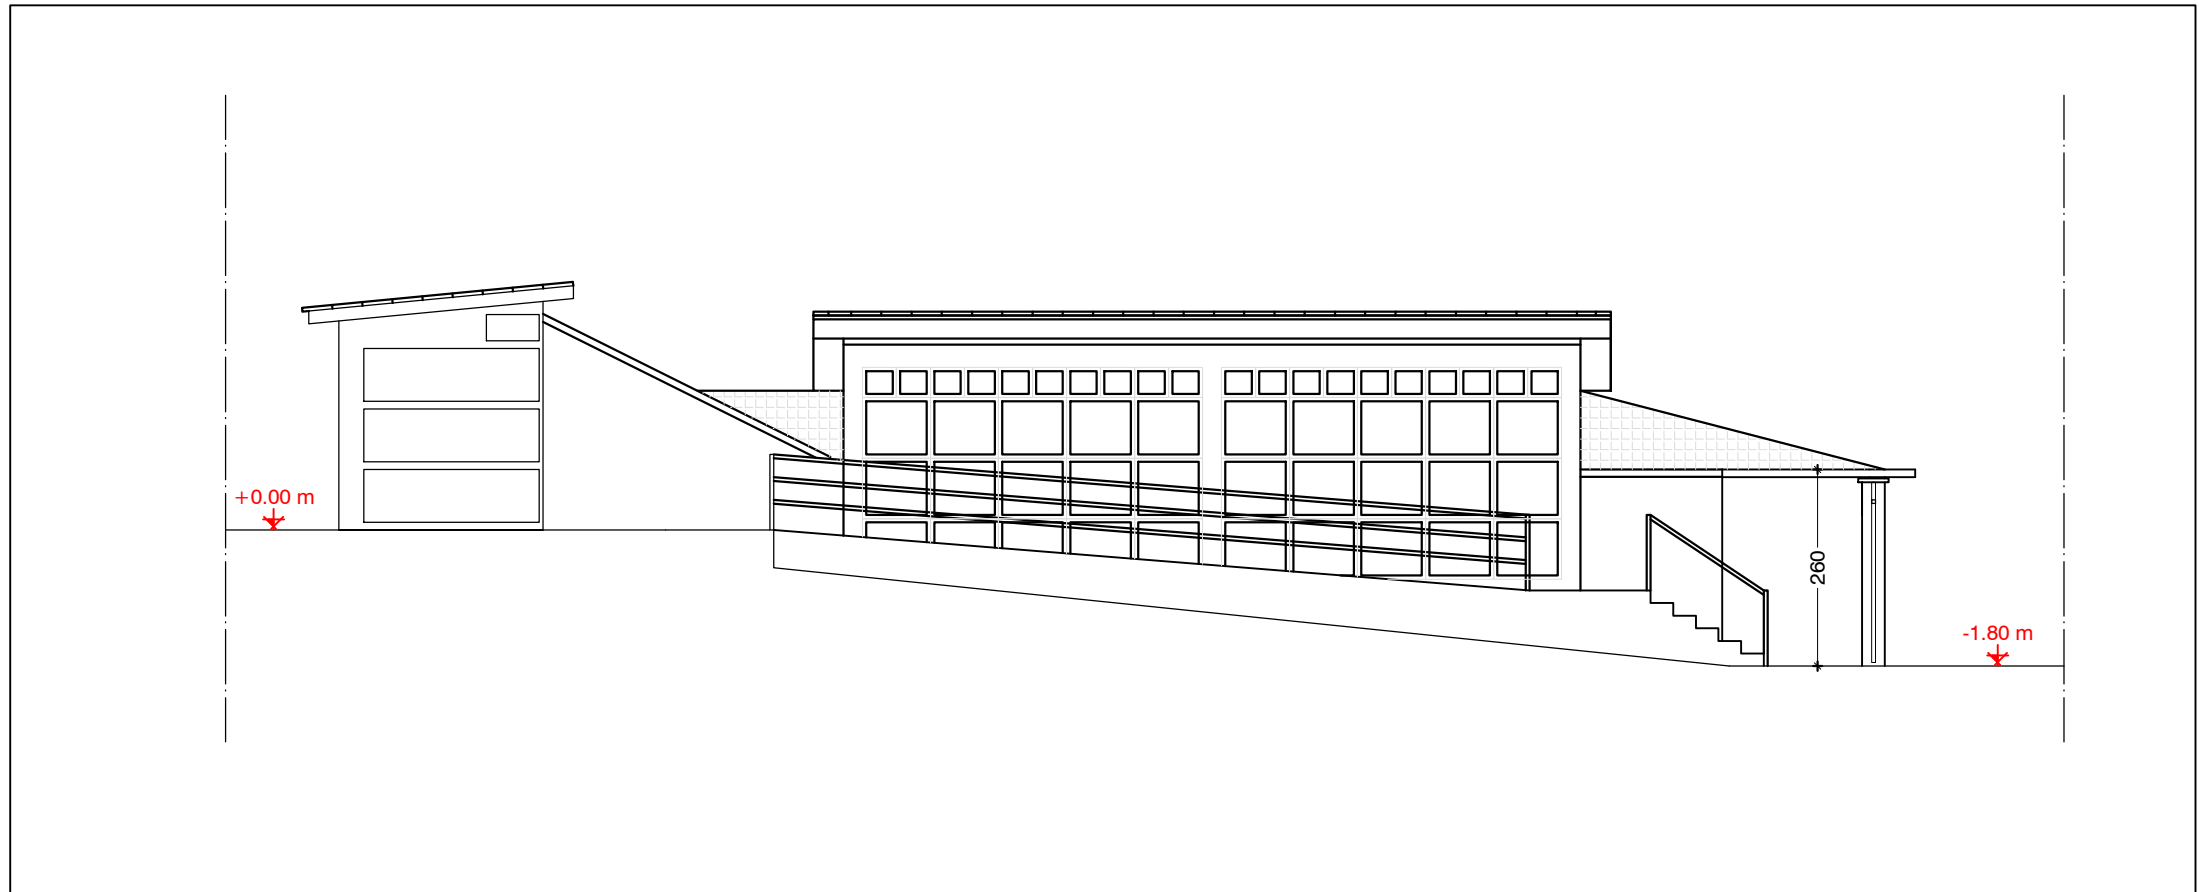


SCHEMA FUNZIONALE
scala 1:500



0 5 10 50



STATO DI FATTO

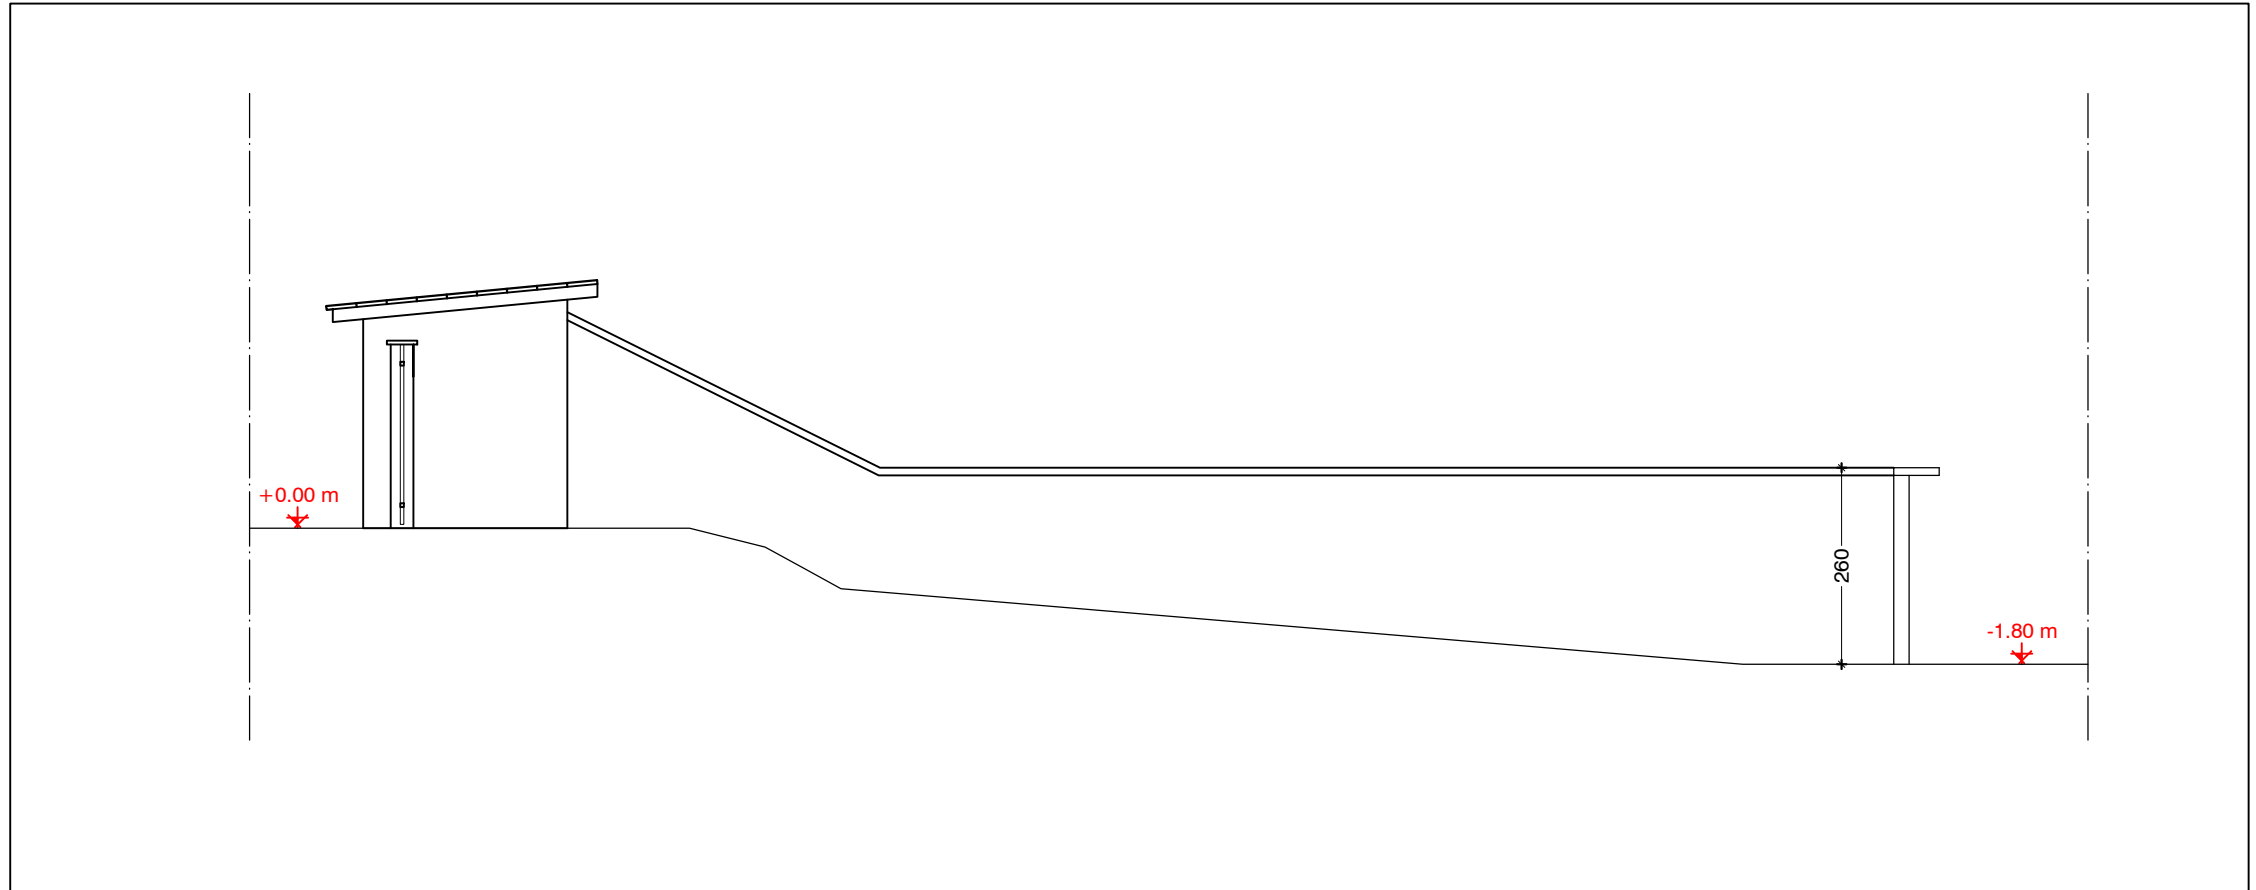

STATO DI PROGETTO

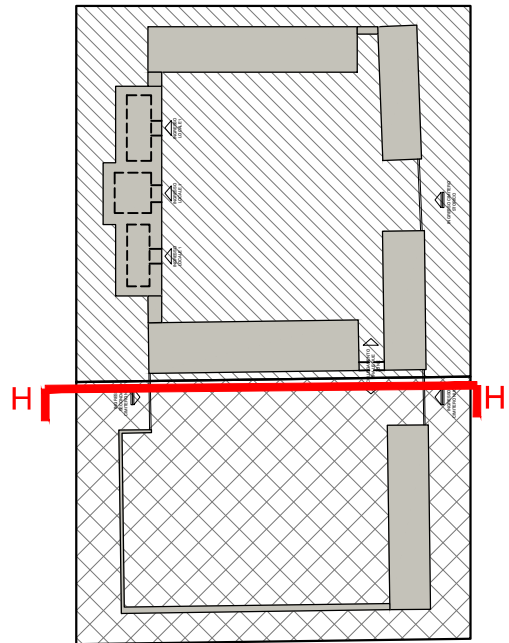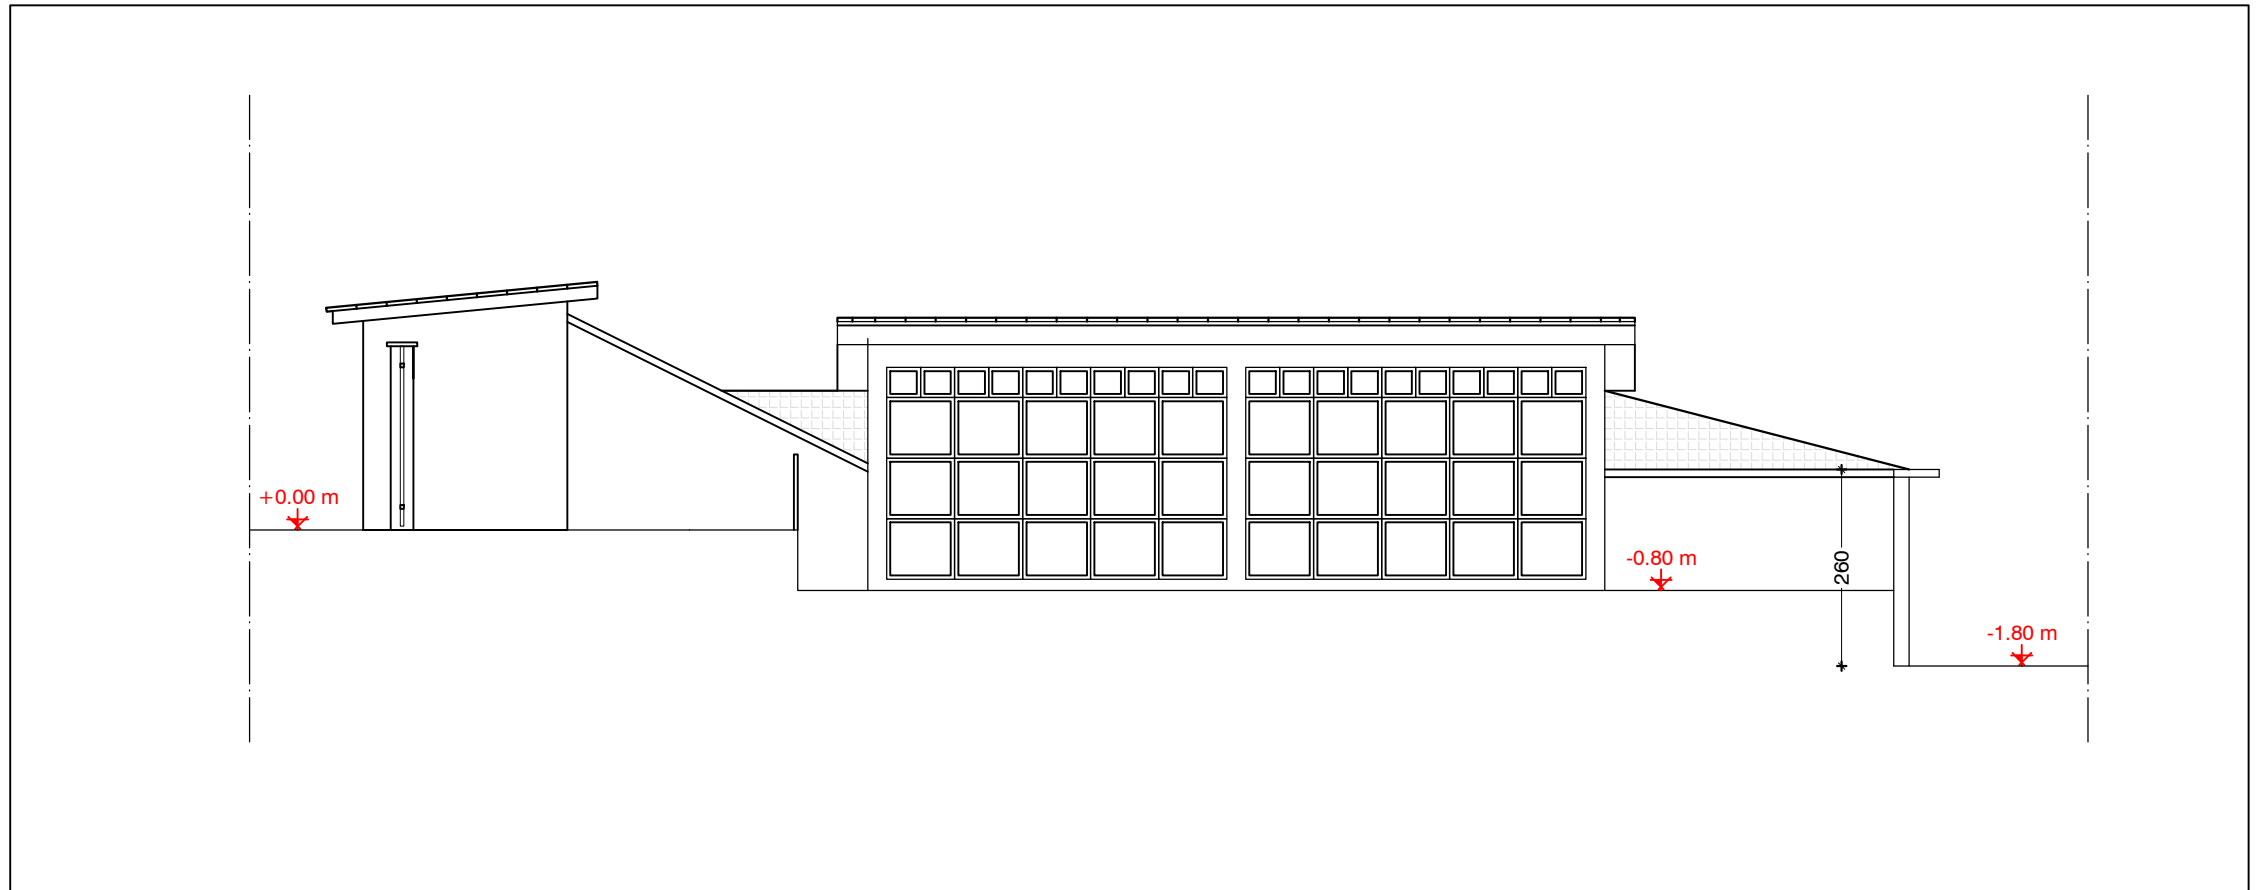


SCHEMA FUNZIONALE
scala 1:500



0 5 10 50



STATO DI FATTO

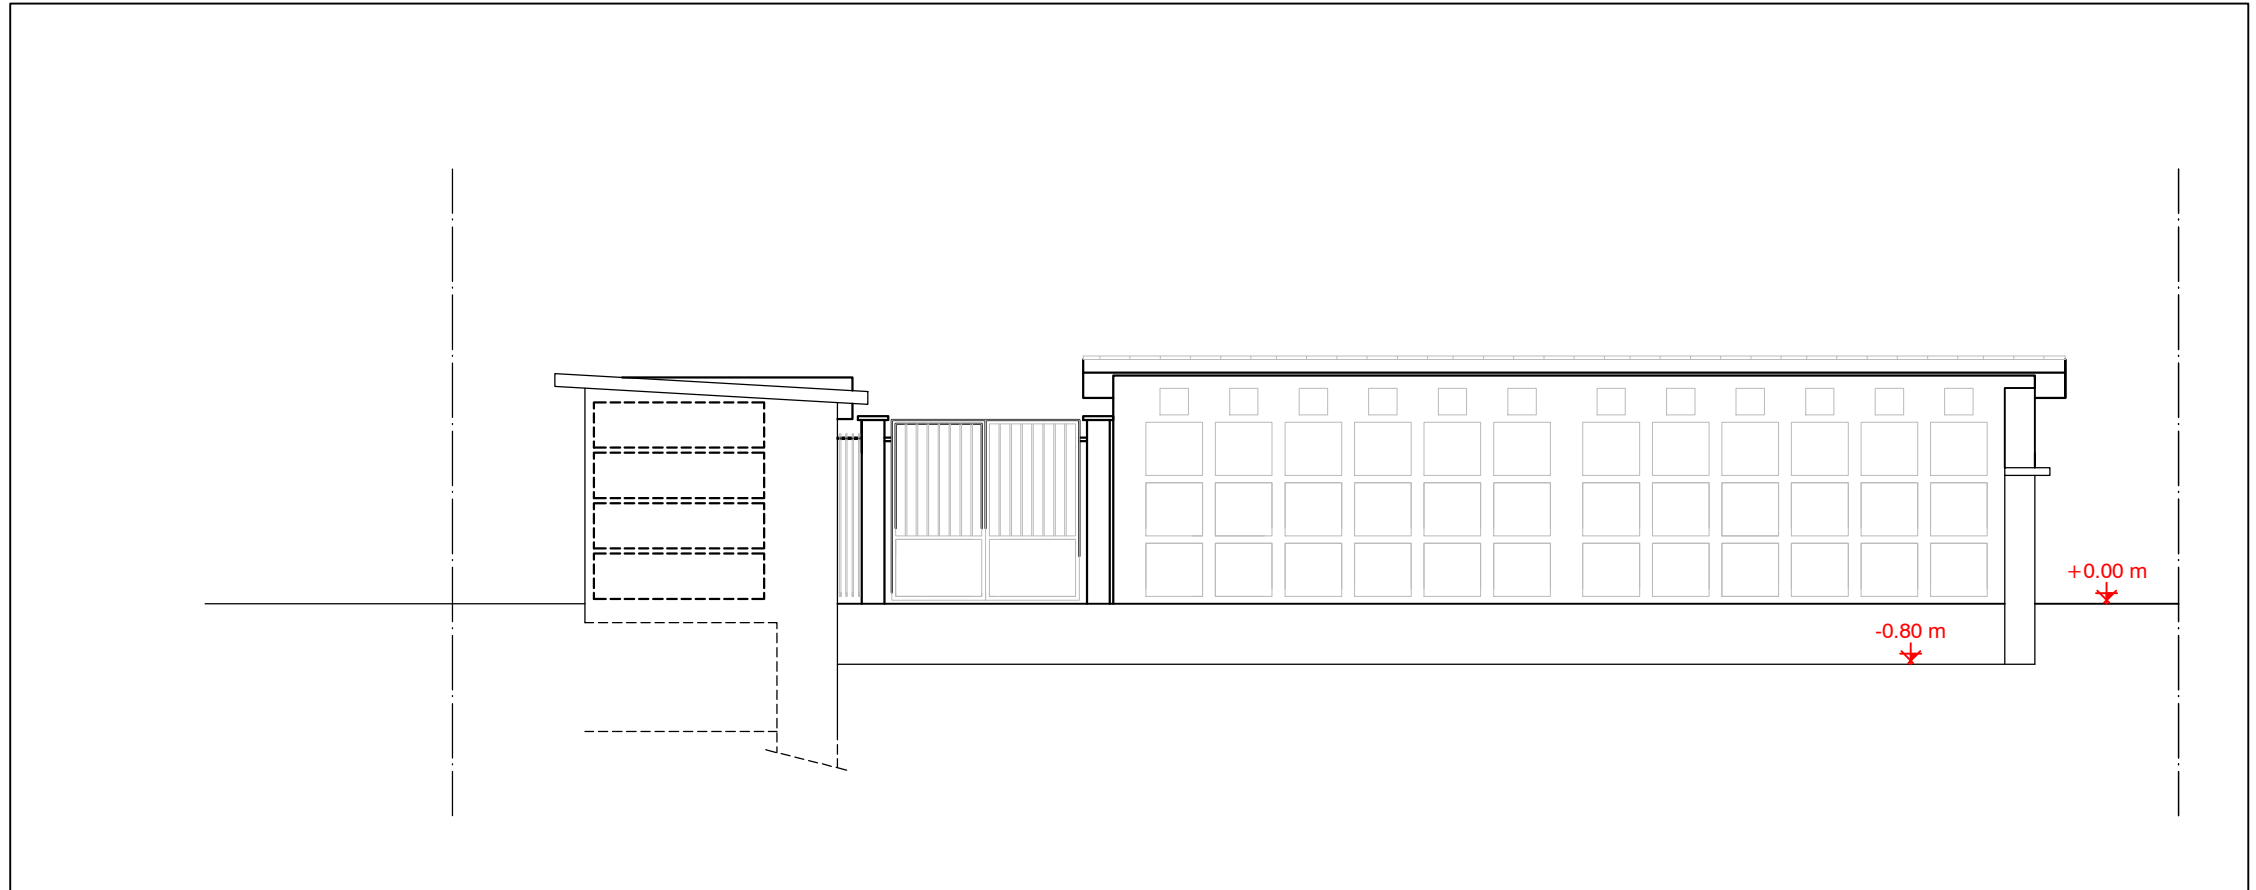

STATO DI PROGETTO

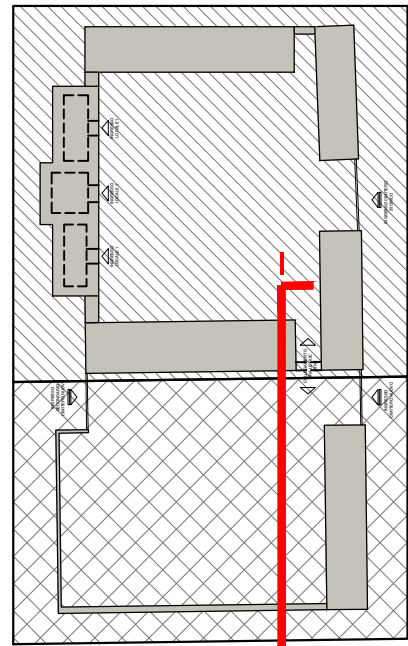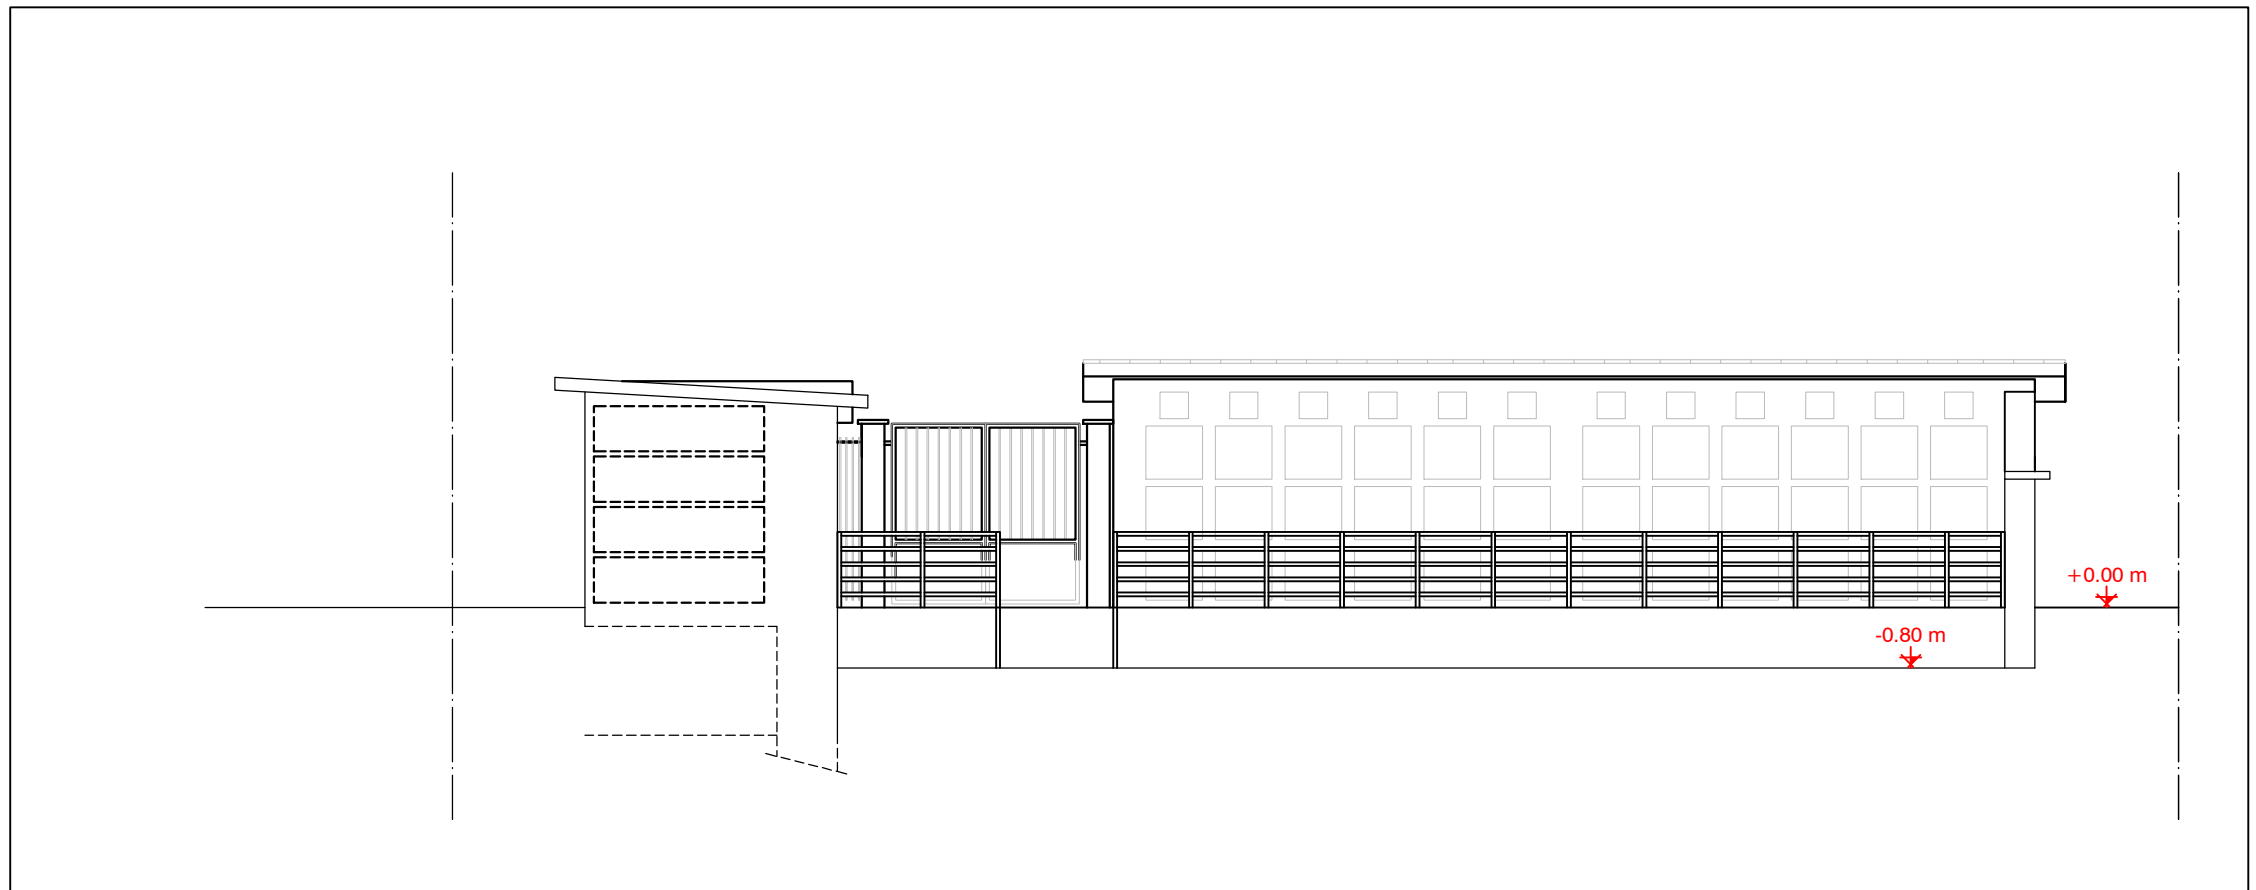

SCHEMA FUNZIONALE
scala 1:500

0 5 10 50

